

# **DISTRICT COURT COMPLEX AT DEHRADUN**



**A Thesis Submitted  
in Partial Fulfillment for the Requirements  
for the Degree of**

## **BACHELOR OF ARCHITECTURE**

**in**

**Field of specialization(ARCHITECTURE)**

**by**

**POORNIMA RAJ CHAUDHARY**

**Enrollment no.-1150101051**

**Under the guidance of**

**Pr. Mohit Agarwal (Dean of BBDU, Lucknow)**

**&**

**Ar. Ramakant (Assistant prof. of BBDU, Lucknow)**

**to the**

**School of Architecture**



**BABU BANARASI DAS UNIVERSITY,**

**LUCKNOW**

**May,2020**

## ACKNOWLEDGEMENT

The journey which started 5 years ago has culminated...as I step into the world a series of people flash in my memory without whose support and good will this journey wouldn't have been easy and free flowing.....

To start with. First and foremost gratitude towards almighty GOD for his blessings. Then I would like to thank all my faculty members who have supported and guided me all these memorable 5 years.

I would like to thank my thesis guide **PR. MOHIT AGARWAL & AR. RAMAKANT** who has been extremely co-operative since the very beginning and who helped me to utilize my skills and creativity to the utmost...

I would further like to show my gratitude to my juniors for giving full assistance whenever required and being there with me in all ups and downs. Their motivation and support helped me to be more dedicated and inclined towards my goal.

Last but not the least all friends and love one who give their all kind of support and concern .The lovely juniors who helped me whenever Pooja Yadav.Thankyou so much for the efforts.

I have put in my best of efforts and worked day and night to make this project a success .hope u too will appreciate my endeavour.....

I wish to dedicate this work to my love ones.....Who are always their in my heart.

# BABU BANARASI DAS UNIVERSITY, LUCKNOW

## CERTIFICATE OF THESIS SUBMISSION FOR EVALUATION

1. Name : POORNIMA RAJ CHAUDHARY

2. Roll No. : 1150101051

3. Thesis title: DISTRICT COURT COMPLEX,  
DEHRADUN.....

.....

4. Degree for which the thesis is  
submitted:...BACHELOR OF ARCHITECTURE.....

5. Faculty of the University to which the thesis is  
submitted

.....

.....

- |  |     |                            |                          |
|--|-----|----------------------------|--------------------------|
| 6. Thesis Preparation Guide was referred to for preparing the thesis.      | YES | N <input type="checkbox"/> | <input type="checkbox"/> |
| 7. Specifications regarding thesis format have been closely followed.      | YES | N <input type="checkbox"/> | <input type="checkbox"/> |
| 8. The contents of the thesis have been organized based on the guidelines. | YES | N <input type="checkbox"/> | <input type="checkbox"/> |
| 9. The thesis has been prepared without resorting to plagiarism.           | YES | N <input type="checkbox"/> | <input type="checkbox"/> |
| 10. All sources used have been cited appropriately.                        | YES | N <input type="checkbox"/> | <input type="checkbox"/> |
| 11. The thesis has not been submitted elsewhere for a degree.              | YES | N <input type="checkbox"/> | <input type="checkbox"/> |
| 12. Submitted 4 spiral bound copies plus one CD.                           | YES | N <input type="checkbox"/> | <input type="checkbox"/> |

.....  
Signature(s) of the Guide  
PR. MOHIT AGARWAL & AR. RAMAKANT  
BBDU, Lucknow.

(Signature of the Candidate)  
Name: Poornima Raj Chaudhary  
Enrollment no. 1150101051

# **BABU BANARASI DAS UNIVERSITY**

**B. Arch Thesis 2018-2019**

## **Certificate**

Name of Student: POORNIMA RAJ CHAUDHARY ,Roll no. 1150101051

Department: .....

Thesis Title (in capital): DISTRICT COUT COMPLEX AT DEHRADUN

Thesis guide: ...**PR. MOHIT AGARWAL & AR. RAMAKANT**

Remarks: Satisfactory / not Satisfactory (in case of not Satisfactory give comments):

.....  
.....  
.....

---

**Sign of Thesis**

**Guide**

---

**Thesis coordinator**

---

**Sign of Head of**

**Department**

---

**Sign of External**

**Examiner 1**

---

**Sign of External**

**Examiner 2**

---

**Sign of Dean of**

**School**

# CONTENT




1. INTRODUCTION
2. LIBRARY STUDY
3. SITE AND CLIMATE STUDY
4. CASE STUDY
  1. HIGH COURT LUCKNOW
  2. SAKET DISTRICT COURT
5. LITRATURE STUDY
  1. HAIFA COURT HOUSE, ISRAEL
  2. CEAN LAW COURT, FRANCE
6. COMPARATIVE ANALYSIS
7. INFERENCES
  1. REQUIREMENTS
  2. AREA ANALYSIS
8. CONCEPET DESIGNING
9. SITE PLAN WITH AREA CALCULATON
10. ALL FLOOR PLANS, ELEVATION, SECTION
11. ELECTIVE DRAWING 1 ( LANDSCAPE)
12. ELECTIVE DRAWING 2 ( PLUMBING)
13. FINAL VIEWS / MODEL
14. BIBLIOGRAPHY

# INTRODUCTION

Dehradun is located in the Doon Valley on the foothills of the Himalayas nestled between the river Ganges on the east and the river Yamuna on the west. The city is famous for its picturesque landscape and slightly milder climate and provides a gateway to the surrounding region. The construction of district court complex is proposed at Village-Uddiwala Karanpur, Pargana-Central Doon, Haridwar Road, Tehsil & District- Dehradun, Uttarakhand. The developer of the project is National Buildings Construction Corporation. The Land use of project site is in conformity with Dehradun Master Plan.

## **COURT**

law court are shelters of law” court is the word which denotes an enclosed space. it is a term used for judicial tribunals which originally were enclosures within which sat judges and their officials while the counsel attorneys and the general public stood outside the bar of the court

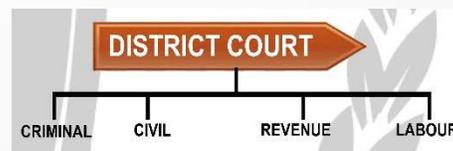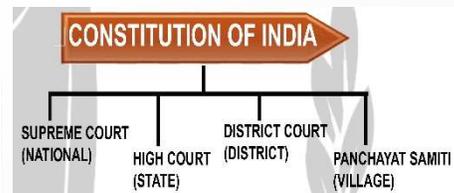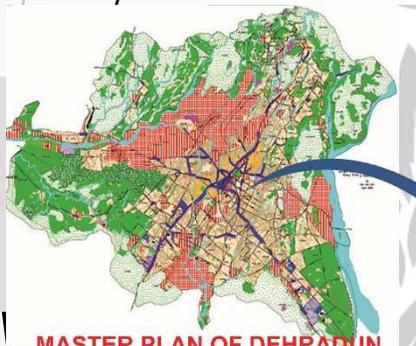

**D  
I  
S  
T  
R  
I  
C  
T  
  
C  
O  
U  
R  
T**

The site has been proposed keeping in mind the number of future development of this area. though till now, the area houses only a few number of residences, it offers a lot of future prospects in case of development which generate the need of a judiciary system in this place in order to establish law and order.



## **COMPONENTS OF PROJECT**

1. ADMINISTRATION BLC
2. JUDGE'S BLOCK
3. LOWYER'S BLOCK
4. PRISONER'S CELL
5. COURT ROOM



D  
I  
S  
T  
R  
I  
C  
T  
  
C  
O  
U  
R  
T

### **REQUIREMENTS OF DISTRICT COURT**

1. A large dais to accommodate a large table and an executive chair with sufficient space for movement towards the sides and rear.
2. The dais should be raised by about 450 to 600 mm from the court room floor level.
3. The dais has to be directly approachable from the judge's chamber.
4. The size of the judges table on the dais should be large enough to accommodate two chairs.
5. The table should have provision for power outlet, computer LAN outlet and video conferencing facilities.

### **COURT ROOM**


1. A court room is said to acoustically good when it has a proportion of 1:1.2 to 1:1.5 .
2. Shapes and sizes are guided by good hearing seeing conditions.
3. All walls and ceilings should be acoustically treated for indoor and outdoor conditions.

### **COURT OFFICE**

1. PROVISION 1/2 PER COURT ROOM AREA  
ONE PER COURT ROOM= 30 SQM.  
TWO PER COURT ROOM= 80 SQM.



PART PLAN (SHOWING TYPICAL JUDGE'S CHAMBER ARRANGEMENT)  
(SHOWING LABOURY JUDGE'S CHAMBER ARRANGEMENT)  
SCALE 1:50

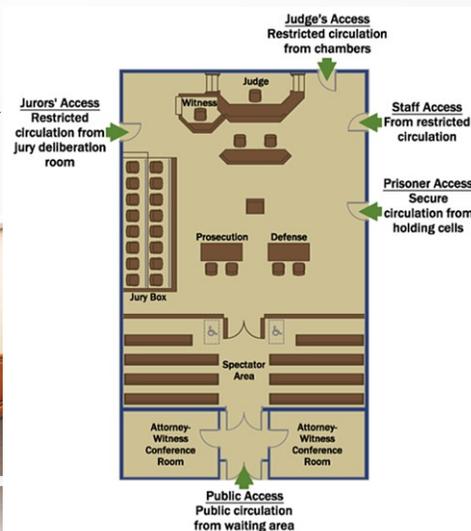

## COURT CORRIDOR

1. 1.8 M. MIN. WITH NON SLIP SURFACE AND ACOUSTICAL
2. MET SHOULD BE USED.





## ACOUSTICS

1. The height of the room may vary between 16' -20'
2. The ceiling should be flat or splayed only at the walls.
3. Deep beams transversing the ceiling parallel to the dais should be avoided
4. The angles between walls and ceilings should be designed to prevent echoes .
5. Seating should be upholstered to assist the maintenance of a low period of reverberations when the number of people present in small.
6. The reverberation period should not be more than 1 second.

## WITNESS BOX

1. A witness box of proper size and design (with hand rails).
2. The witness box should be raised by 150 mm to 200 mm from the court room floor level and should have a chair for sitting.
3. An enclosure for the accused on the other side of the dais facing the witness box with a bench capable of seating at least 3 persons
4. Space for two tables: one for the court master (Reader) and one stenographer, in front of the dais with provision for electrical points for connecting computers
5. Lawyers desks, designed to have space for storage of books and files.
6. Space for lawyers to stand and argue etc.
7. Moving the witness box 45 degree to face diagonally across the court room would improve the courts view but impair that of the judge's .
8. A better modification might be to give the front of the witness box a less directional and more rounded shape .

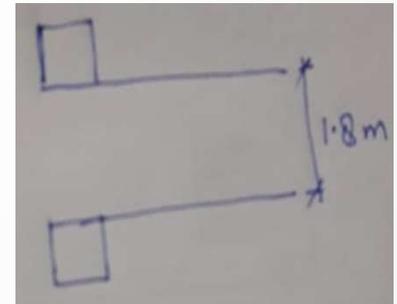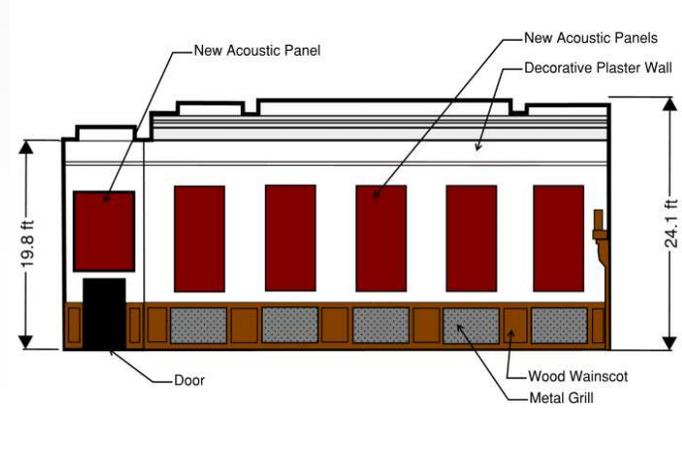

8. A better modification might be to give the front of the witness box a less directional and more rounded shape . Generally one is enough . However two are generally provided to maintain uniformity and interchangeability while necessity is felt to use both simultaneously.



## BAR ROOM

1. Designed for max. ¾ capacity of lawyer's chamber 2 sqm/person
2. 200×2 = 400 Sqm
3. 30 % circulation 120 Sqm
4. 20% lockers / store 80 Sqm

## LAWYERS CHAMBER

1. Provision ½ lawyers .
2. Unit area 15 Sqm for one lawyer.
3. 30 Sqm for two lawyers

## DIAS

1. The dias should consist of masonry platform, the floor of which should be kept 2' higher the floors of the court room .
2. The tables and chairs for readers and stone to kept at the same level.
3. When there are some special type of cases , eg. Criminal, more spaces is needed so the court should be designed for more number of people or long wall should be kept free so that when required seats may be provided the seats should be with minimum comfort .
4. They are meant for person having special interest .
5. So some courts should be provided 2 sqm/ person including overflow space along long wall or back wall.

## LIFT

### Standard Dimensions & Reactions

(unit:mm)

Type	Model	Speed (m/min)	Clear Opening	CAR		Hoistway	Machine Room	Machine Room Reaction (Kg)	
				Internal	External			R1	R2
Standard	B750-2S	30	1100	1300 x 2300	1360 x 2530	2050 x 2850	2300 x 3500	5790	3450
	B750-2S	60						5900	3750
	B1000-2S	30	1200	1500 x 2500	1560 x 2730	2300 x 3050	2750 x 4000	6500	3700
	B1000-2S	60						6800	4100
Transfix	B750-2SD	30	1100	1300 x 2300	1360 x 2700	2050 x 3100	2300 x 3500	5790	3450
	B750-2SD	60						5900	3700
	B1000-2SD	30	1200	1500 x 2500	1560 x 2900	2400 x 3300	2750 x 4000	9300	3700
	B1000-2SD	60						9500	4100

## STAIR CASE


1. Minimum two stair case , should not 760 mt apart
2. Minimum width 1.2 m
3. Railing on both sides of flight
4. Should be well lighted and ventilated
5. Should not have flight more than 14 risers without landing
6. Should have slope 1:12
7. Properly lighted and ventilated should be fire proof.

## RAMP

1. Slope should be at least 1:12 properly lighted and ventilated.
2. Non slippery acoustically good minimum width 1500 mm.

## RETIRING ROOM

1. Provision 1 PER COURT
2. Unit area WITH ATTACHED TOILET = 28.7 SQM.

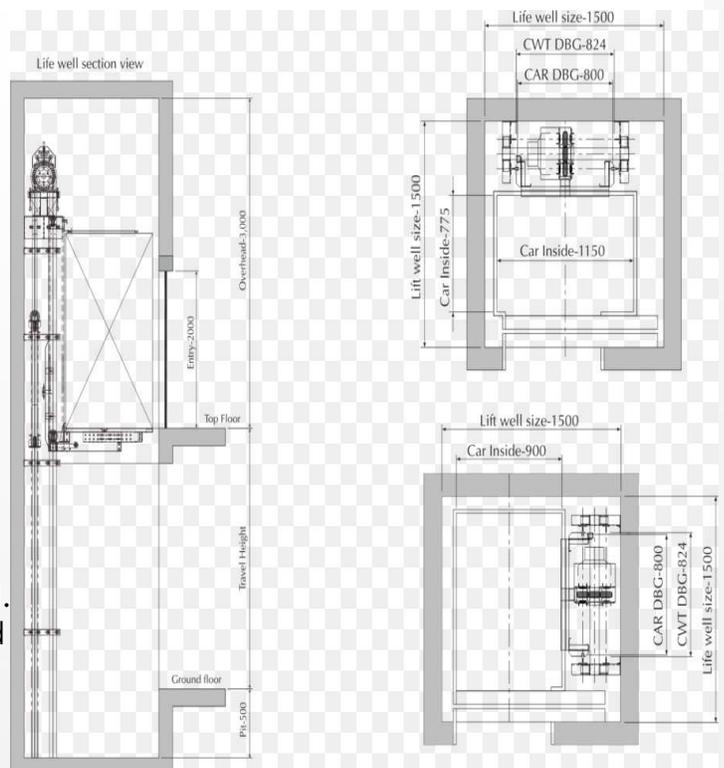


## PARKING:-

1. Car parking 3 sqm/car
2. Total 1000 sqm/300 car
3. Scooter 0.08 Sqm/ scooters  
= 80 /1000 scooters
4. Cycle 0.06 sqm cycle = 60/1000 cycle.



## STANDARDS FOR UNDERGROUND PARKING

1. Access drive width
2. Minimum width -18' for 2 way travel and 9' for one way
3. Maximum width-24'  
Entrance/ exit curb -cuts -  
minimum 10' radius curb return  
Minimum parking staff size within  
underground parking facilities  
9'x18'
4. Minimum height clearance- 1'


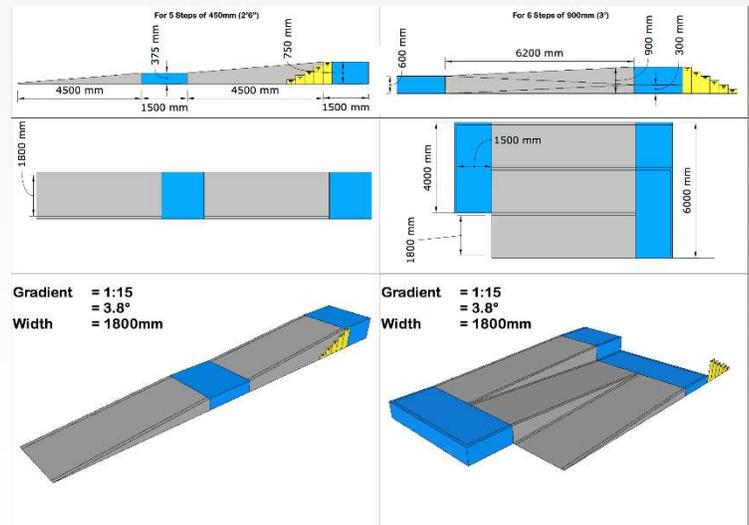


## UTILITY BLOCK

1. hospital
2. public toilet
3. photocopy
4. shops
5. bank
6. atm
7. crpf room
8. mediation rm.

## RESTAURANTS

1. Size are based on number of people /sqm, circulation  
one requires table of 60 cm wide and 40 cm deep.
2. The minimum of escape route is 1.00 m/150 people .
3. Area required per person is 2 m.sq.

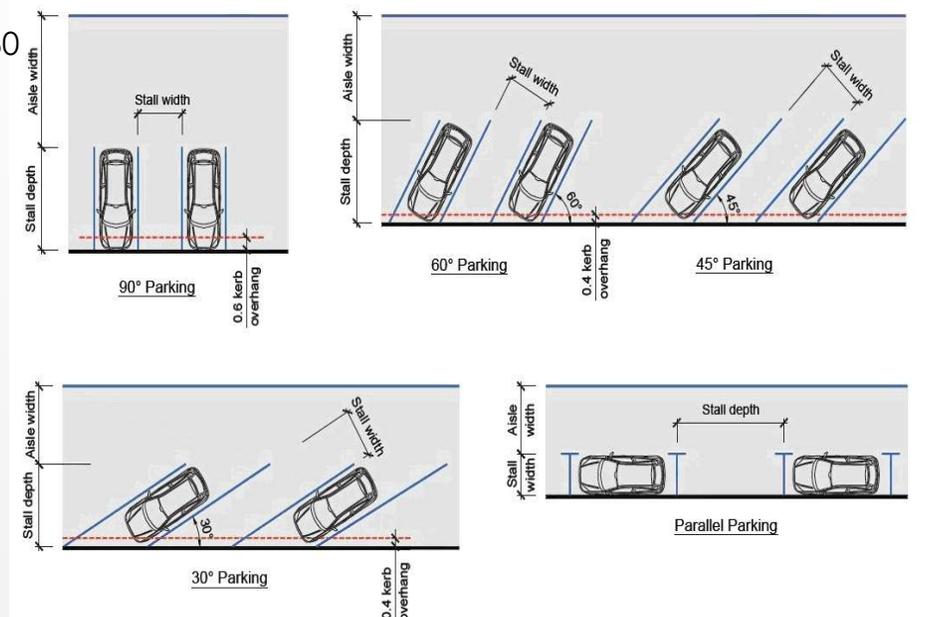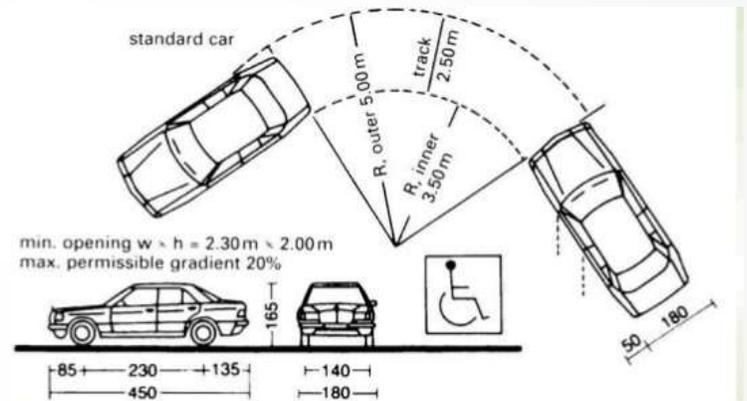

# SITE STUDY

## INTRODUCTION

- ❑ Dehradun is located in the Doon Valley on the foothills of the Himalayas nestled between the river Ganges on the east and the river Yamuna on the west.
- ❑ The city is famous for its picturesque landscape and slightly milder climate and provides a gateway to the surrounding region.
- ❑ It is well connected and in proximity to Himalayan tourist destinations such as Mussoorie, and Auli and the Hindu holy cities of Haridwar and Rishikesh along with the Himalayan pilgrimage circuit of Chota Char
- ❑ The construction of district court complex is proposed at Village-Uddiwala Karanpur, Pargana-Central Doon, Haridwar Road, Tehsil & District- Dehradun, Uttarakhand.
- ❑ The developer of the project is National Buildings Construction Corporation. The Land use of project site is in conformity with Dehradun Master Plan.

## SITE LOCATION

- ❑ The district court complex is proposed at Village-Uddiwala Karanpur, Pargana-Central Doon, Haridwar Road, Tehsil & District- Dehradun, Uttarakhand. The developer of the project is National Buildings Construction Corporation. The Land use of project site is in conformity with Dehradun Master Plan.



**DEHRADUN HILL**



**D  
E  
H  
R  
A  
D  
U  
N  
  
C  
I  
T  
Y**

## SITE SURROUNDING

- ❑ Project site is located at Village-Uddiwala Karanpur, Pargana-Central Doon, Haridwar Road, Tehsil & District- Dehradun, Uttarakhand.
- ❑ The location coordinate of project site are 280 25' 57.09" N and 770 30' 14.72" E. The Project site is well connected to the Major National highways NH-72 and NH-72A, which is at the distance of about 150 m, N and 1.4 km, W from the project site.
- ❑ Nearest Air Port is Jolly Grant Airport which is about 27.0 Km.



## **BOUNDRIES:**

Dehradun is located in the Doon Valley on the foothills of the Himalayas nestled between the river Ganges on the east and the river Yamuna on the west.

- ❑ EAST: OTHER GOVERNMENT PROPERTY
- ❑ WEST: COMMERCIAL COMPLEX
- ❑ SOUTH: OTHER PROPERTY
- ❑ NORTH: HARIDWAR Master Plan.




## **SURROUNDING OF THE PROJECT SITE**

- ❑ **NEAREST NATIONAL HIGHWAY:** NH 72 - .15 KM North NH 72A - 1.4 KM West
- ❑ **AIRPORT:** Jolly Grant Airport: 27 Km, SE
- ❑ **RAILWAY STATION:** Dehradun Railway Station: 750 m, W.
- ❑ **NEAREST TOWN/CITY:** Dehradun-1.0 km
- ❑ **River Body:** Song river : 7.1 km, E
- ❑ **National Parks:** Raja Ji National Park : 7.0 km, SW
- ❑ **State Boundary:** UP-Uttarakhand Border : 13 km, SW
- ❑ **Seismicity:** The study area falls under Seismic Zone-IV



## **SITE CONNECTIVITY**

- ❑ The Project site is well connected to the Major National highways NH-72 and NH72A, which is at the distance of about 150 m, N and 1.4 km, W from the project site. Almost all the surrounding and
- ❑ nearby areas are connected with network of roads. Dehradun Railway Station is around 750 meter in West direction.

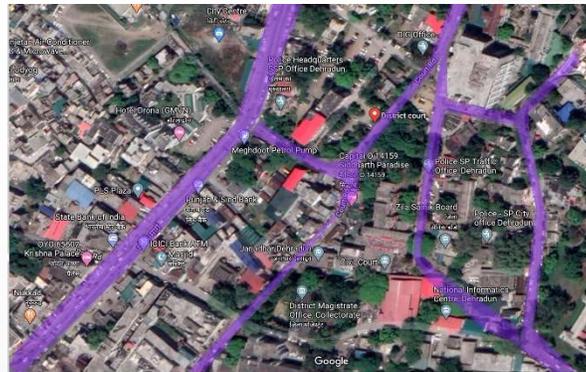

**ROAD NETWORK**



**D  
E  
H  
R  
A  
D  
U  
N  
  
C  
I  
T  
Y**

**SOIL OF SITE:**

**SOIL TYPE:** alluvial soil

**SOIL CAPACITY:**

- ❑ Dehradun and other plains areas of Uttarakhand see almost as much rainfall as coastal Maharashtra and more than Assam.
- ❑ Agriculture benefits from fertile alluvial soil, adequate drainage and plentiful rain.



**SOIL OF SITE**



**D  
E  
H  
R  
A  
D  
U  
N  
  
C  
I  
T  
Y**

**SEWAGE AREA**

- ❑ SEWAGE PLANT PROVIDED 2.5 DISTANCE FROM SITE& DRAINAGE POLES PROVIDE ON SITE.

**ELECTRICITY**

- ❑ TRANSEFORMER PLACED AT DISTANCE 1 KM.




**WATER SUPPLY**

- ❑ The water supply for the propsoed project during operation phase will be sourced from water supply department of Dehradun. The total water demand works out to approximately 298 KLD.
- ❑ After recycling and reuse of 236 KLD treated water, the net fresh water requirement will be 62 KLD, which works out to 21.34% of estimated total water demand..



**CLIMATE**

- ❑ The climate of Dehradun is humid subtropical.
- ❑ Summer temperatures can reach up to 44 °C for a few days and a hot wind called Loo blows over North India. Winter temperatures are usually between 1 and 20 °C and fog is quite common in winters like plains. Although the temperature in Dehradun can reach below freezing during severe cold snaps,[24] this is not common. During the monsoon season, there is often heavy and protracted rainfall. Dehradun and other plains areas of Uttarakhand see almost as much rainfall as coastal Maharashtra and more than Assam. Agriculture benefits from fertile alluvial soil, adequate drainage and plentiful rain.

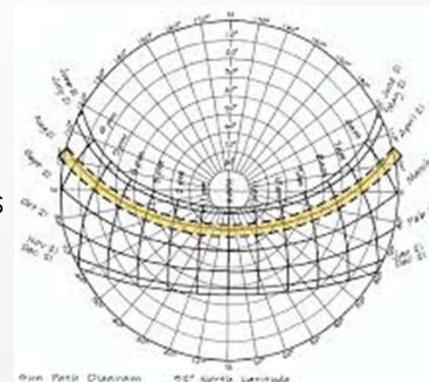

Sun Path Diagram 28° North Latitude

**SUN PATH DIAGRAM**

Climate data for Dehradun (2001-2019, extremes 2001-2020)													[hide]
Month	Jan	Feb	Mar	Apr	May	Jun	Jul	Aug	Sep	Oct	Nov	Dec	Year
Record high °C (°F)	28.6 (83.5)	31.2 (88.2)	37.2 (99.0)	40.8 (105.4)	43.1 (109.6)	43.9 (111.0)	40.6 (105.1)	37.2 (99.0)	36.6 (97.9)	36.1 (97.0)	30.6 (87.1)	27.4 (81.3)	43.1 (109.6)
Average high °C (°F)	19.8 (67.6)	22.1 (71.8)	26.8 (80.2)	32.3 (90.1)	34.8 (94.6)	34.2 (93.6)	30.7 (87.3)	30.0 (86.0)	29.9 (85.8)	28.8 (83.8)	25.3 (77.5)	21.5 (70.7)	28.0 (82.4)
Average low °C (°F)	6.2 (43.2)	8.4 (47.1)	12.5 (54.5)	16.8 (62.2)	20.6 (69.1)	22.7 (72.9)	23.1 (73.6)	22.6 (72.7)	20.8 (69.4)	15.6 (60.1)	10.8 (51.4)	7.2 (45.0)	15.6 (60.1)
Record low °C (°F)	-1.1 (30.0)	-1.1 (30.0)	2.2 (36.0)	7.2 (45.0)	11.3 (52.3)	13.1 (55.6)	13.2 (55.8)	18.0 (64.4)	14.3 (57.7)	8.4 (47.1)	2.8 (37.0)	0.0 (32.0)	-1.1 (30.0)
Average rainfall mm (inches)	41.5 (1.63)	58.2 (2.29)	53.1 (2.09)	34.5 (1.36)	61.5 (2.42)	231.7 (9.12)	642.5 (25.30)	666.4 (27.02)	298.3 (11.74)	44.4 (1.75)	7.7 (0.30)	23.8 (0.94)	2183.5 (85.96)
Average rainy days	2.9	3.9	3.6	2.9	4.5	9.6	20.5	21.5	11.9	2.2	0.5	1.5	85.7
Average relative humidity (%) (at 17:30 IST)	65	56	45	34	37	53	78	82	76	65	67	69	61



# D E H R A D U N C I T Y

## VEGETATION

SN	Botanical Name	Common Name
1	<i>Ficus Infectoria</i>	Pakur
2	<i>Delonix regia</i>	Gulmohur
3	<i>Cassia fistula</i>	Amaltas
4	<i>Azadirachtha Indica</i>	Neem
5	<i>Peltophorum ferrugineum</i>	Copper pod
6	<i>Ficus retusa</i>	Usha
7	<i>Alstonia Scholaris</i>	Scholar tree
8	<i>Thespesia populnea</i>	Paras Pipal
9	<i>Churasia tabularis</i>	Chukrasia
10	<i>Anthocephalus cadamba</i>	Kadamba
11	<i>Jacaranda mimosifolia</i>	Jacaranda
12	<i>Mimusops Elengi</i>	Maulsari

# CASE STUDY 1

## HIGH COURT AT LUCKNOW



### INTRODUCTION

- ❑ The new Lucknow HC enjoys a very large site, which provides for great opportunities.
- ❑ The absence of area restrictions (as permissible total builtup is far greater than the actual project requirements) along with no height restrictions create a good setting for impressive and iconic architecture.
- ❑ This could be the opportunity to design a court block which could set precedents for the future.

- ❑ **TYPE OF PROJECT:** LAW COURT
- ❑ **LOCATION:** LUCKNOW
- ❑ **ARCHITECT:** NIRMAN NIGAM
- ❑ **CLIENT:**
- ❑ **SITE AREA:** 40 ACRE.
- ❑ **GROUND COVERAGE AREA:** 35 %
- ❑ **HEIGHT:** 17.5 M.
- ❑ **TOTAL BLOCKS:** 4 NOS.
- ❑ **NO. OF COURTROOM:** 84.
- ❑ **PARKING:** 1800 CARS.
- ❑ **YEAR:** 2016.

### SITE LOCATION

- ❑ DISTRICT COURT OF SOUTH AND SOUTH EAST DISTRICT.
- ❑ LOCATION AT SAKET , NEW DELHI AT PRESS ENCLAVE ROAD NEAR PUSHP VIAH.
- ❑ APPROACHABLE FROM TWO SIDES.

### SITE ACCESSIBILITY

- ❑ **RAILWAY STATION:** One can reach HIGH COURT LUCKNOW by reaching at GOMTI NAGAR Railway Stations which are located just at a distance of about 4 Kilometers.
- ❑ **Metro STATION:** INDIRA Nagar metro station is just situated at a distance of about 1 Kilometers from HIGH COURT LUCKNOW

### SITE SURROUNDINGS




INDIRA NAGAR METRO STATION



CENEPOLISE MALL



AMBEDKAR PARK

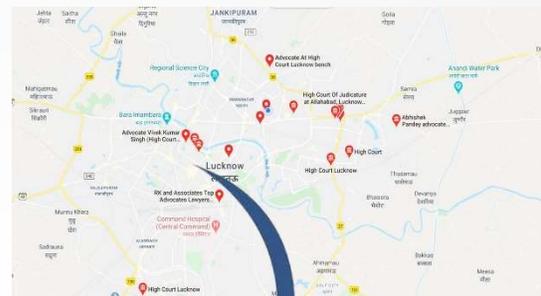


LOCATION OF HIGHCOURT LUCKNOW



SITE OF HIGH COURT LUCKNOW



HIGH COURT LUCKNOW

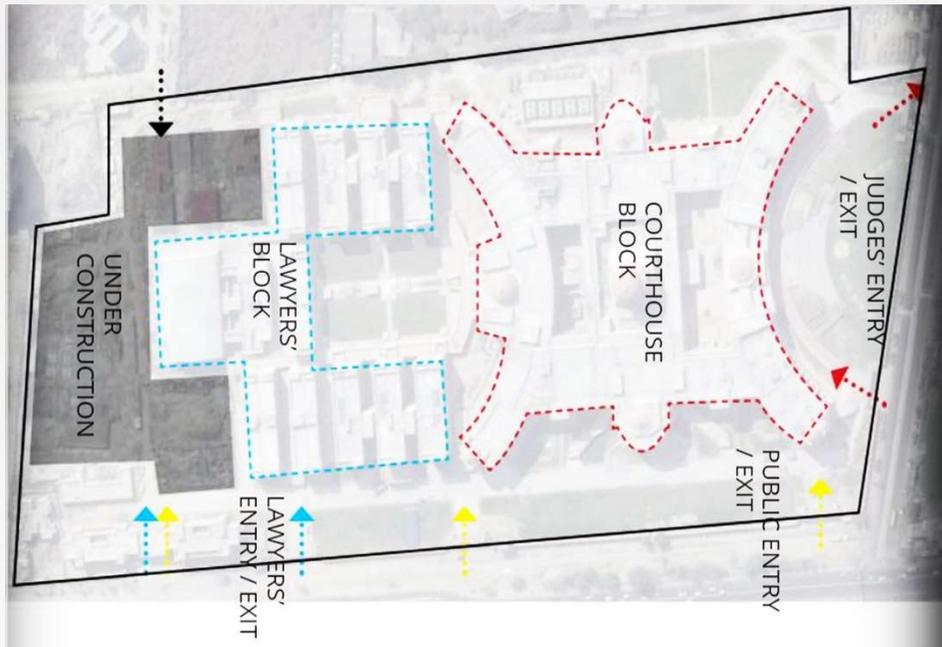

### SITE PLAN OF HIGH COURT

#### SERVICES

##### ELECTRICITY:

- ❑ AVERAGE ELECTRICITY IS REQUIRED 10-12 KV.
- ❑ 2 NOS. 3200 EACH DC IS PROVIDED IN THE BASEMENT- 2
- ❑ ONE POPERATE THE BANQUET HALL & RESTAURANT OTHER FOR THE SUITES.

##### WATER:

- ❑ WATER TANK CAPACITY FOR THE ENTIRE COURT 120000 LTR. TANK IS PLACED IN THE GROUND FLOOR 4 NOS.
- ❑ FIRE TANK EACH HAS 90KL TANK CAPACITY. IT IS ALSO PROVIDED IN THE BASEMENT .2 NOS.
- ❑ TREATMENT TANK HAVING A CAPACITY 150 KL EACH TOTAL AREA OF R/O PLANT ROOM 108 SQMT APPROX. 60KL RAIN WATER HARVESTING.

##### AHU CHILLER:

- ❑ 3 NOS. AHU IS PROVIDED FOR THE COURT & 4 NOS. FOR THE CONCORD HALL.
- ❑ EACH SERVICE HAS A SEPARATE A.H.U. LOCATION OF A.H.U. AT SERVICE FLOOR BETWEEN GROUND FLOOR & FIRD T FLOOR & 2550 MM HEIGHT. 3NOS. CHILLER IN THE BASEMENT LEVEL



❑ **AIRPORT:** DISTANCE ABOUT 24 KM CHAUDHARY CHARAN SIH AIRPORT.

❑ **BUS TERMINAL:** 500 M. AVADH TERMINAL.



## CLIMATE

### **COMPOSITE CLIMATE**

- ❑ COMPOSITE CLIMATE:
- ❑ Lucknow has a humid subtropical climate (Cwa) with cool, dry winters from mid-November to February and dry, hot summers with sunshine from March to mid-May.
- ❑ Half of the rainfall occurs from June to October when the city gets an average rainfall of 896.2 millimetres (35.28 in) from the southwest monsoon winds, and occasionally frontal rainfall from the northeast monsoon will occur in January. In winter the maximum temperature is around 25 °C (77 °F) and the minimum is in the 3 °C (37 °F) to 7 °C (45 °F) range.
- ❑ Fog is quite common from mid-December to late January.
- ❑ Occasionally, Lucknow experiences colder winter spells than places like Shimla and Mussoorie which are situated way high up in the Himalayas.

## CONCEPT



- ❑ HIGH COURT LUCKNOW IS FOLLOW "ENERGY CONSERVATION".
- ❑ Energy conservation is the effort made to reduce the consumption of energy by using less of an energy service.
- ❑ This can be achieved either by using energy more efficiently (using less energy for a constant service) or by reducing the amount of service used (for example, by driving less).
- ❑ Energy conservation is a part of the concept of Eco-sufficiency.

## SITE PLAN


- ❑ Litigants are to enter the court premises from Gate no. 08.

In view of security measures, AND JUDGE AND LAWYERS ENTRY GATE NO. 06 AND 07.

In view of security measures, the litigants will have to undergo manual frisking and their belongings would have to be screened through baggage scanner machines installed at the entry gates.

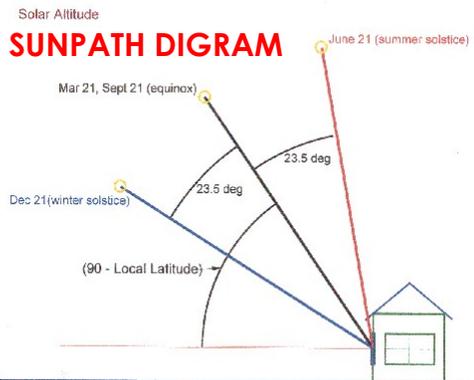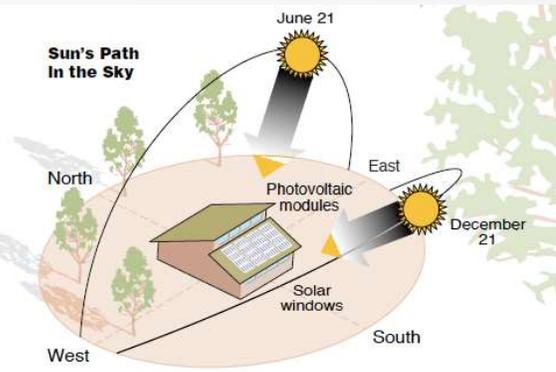


### SUN ANGLE

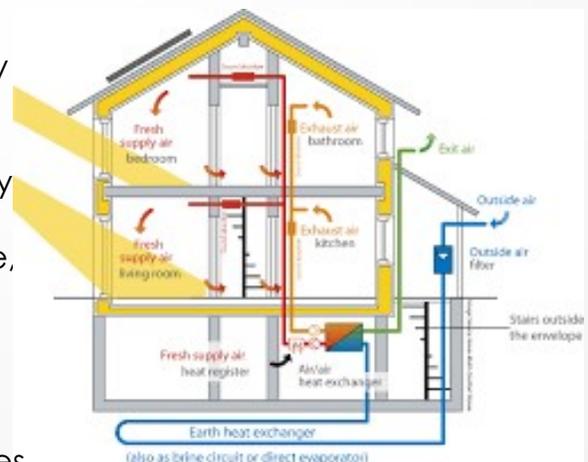

### ENERGY CONSERVATION FEATURE

## FLOOR PLANS

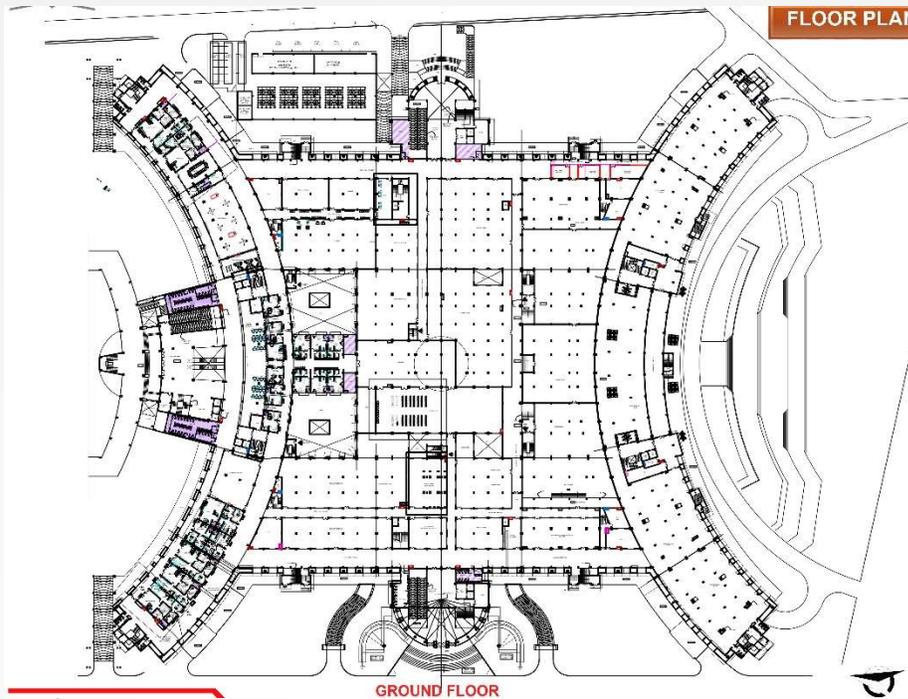

FLOOR PLAN



### COURT:

- ❑ Two Courts have been set up adjacent to the Court Complex at the First Floor and the Second Floor.


- ❑ Special Rooms have been provided in the Family Court at New Delhi District keeping in view the basic needs and requirement of the children who come with their parents to attend the proceedings.

### REQUIRMENT OF GROUND FLOOR PLAN

- ❑ 1). 24 NOS. OFFICES
- ❑ 2). WAITING AREA
- ❑ 3). PUBLIC LOBBY
- ❑ 4). 2 NOS. RECORD ROOM
- ❑ 5). 2 NOS. JUDGES CHAMBERS WITH ATTACHED TOILET
- ❑ 6). 84 NOS. COURTROOM
- ❑ 7). TOILET EVERY FLOORS
- ❑ 8). CONFRENCE ROOM
- ❑ 9). 2 STAIRCASE
- ❑ 10). 2 NOS. LIFT EVERY FLOOR
- ❑ 11). BOARD MEMBERS ROOM
- ❑ 12). MUSIUM
- ❑ 13). LIBRARY



### FIRST FLOOR PLANS

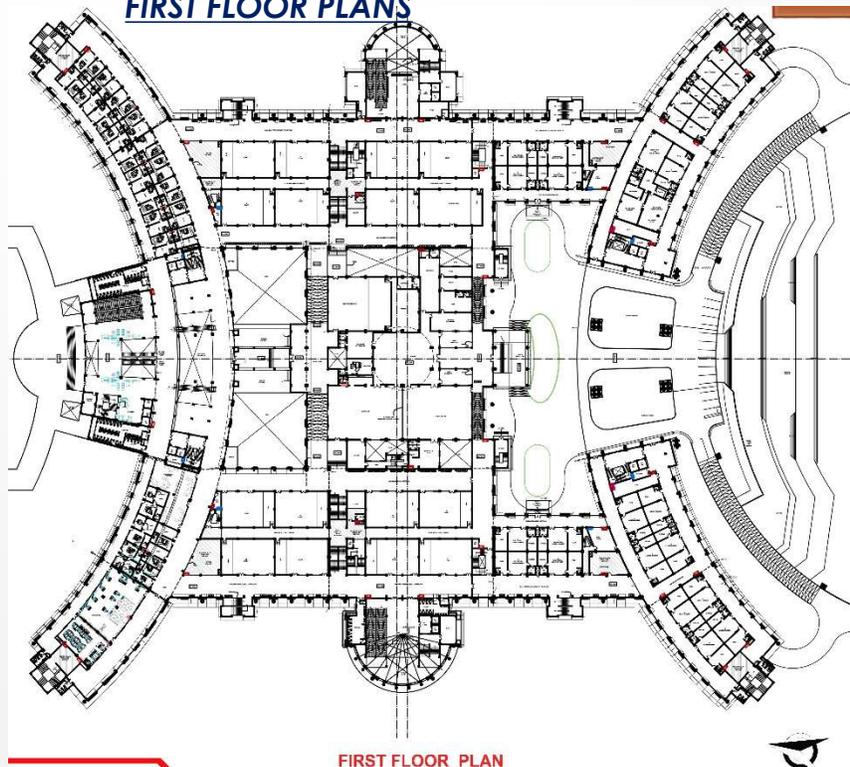


FIRST FLOOR PLAN

## REQUIREMENT OF FIRST FLOOR PLAN

- ❑ 1). VIDEO CONFERENCING
- ❑ 2). CASH BRANCH
- ❑ 3). NAZARAT BRANCH
- ❑ 4). ACCOUNTS BRANCH
- ❑ 5). GENERAL BRANCH
- ❑ 6). ADMINISTRATION BRANCH
- ❑ 7). R&I BRANCH
- ❑ 8). RECORD ROOMS (Sessions)
- ❑ 9). COMPUTER BRANCH
- ❑ 10). CARE TAKING BRANCH
- ❑ 11). COPYING AGENCY
- ❑ 12). LIBRARY
- ❑ 13). COURT ROOM 12 NOS
- ❑ 14). JUDGE DINNING AREA
- ❑ 15). LAWYERS CHAMBERS
- ❑ 16). TOILET
- ❑ 17). OFFICES



## TYPICAL FLOOR PLANS

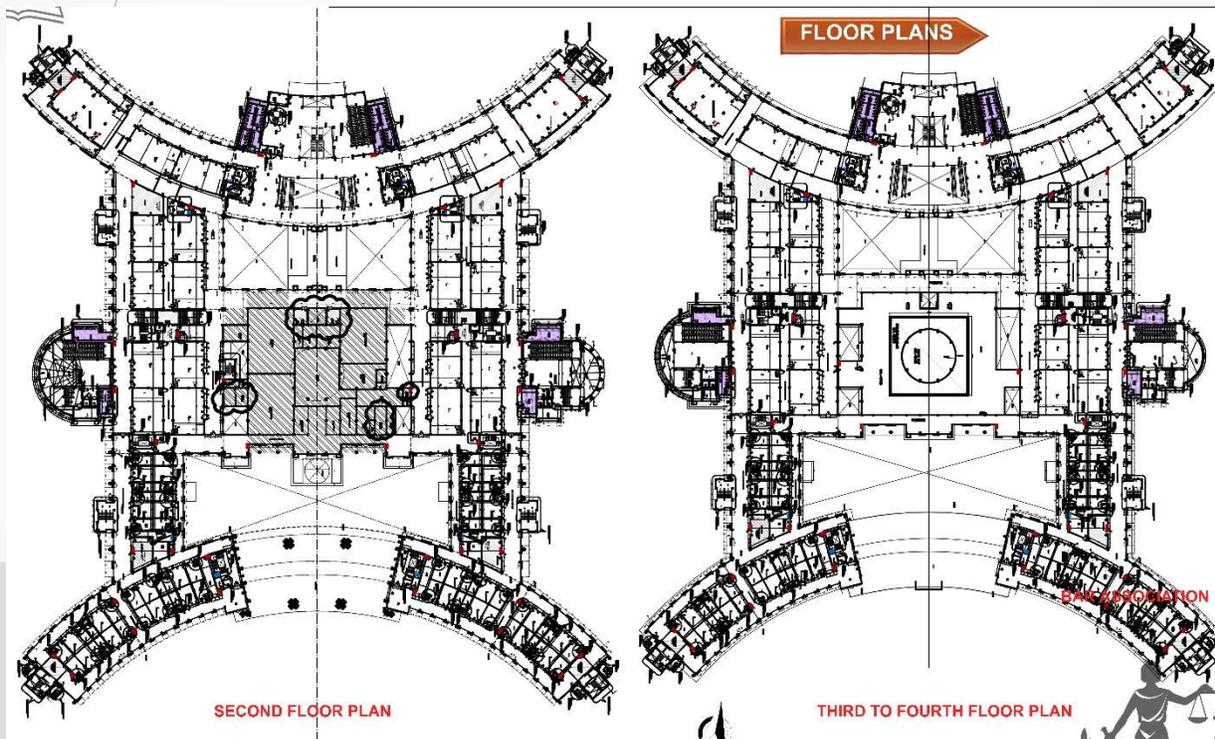

AUDITORIUM



CEILING OF JUDGE CORRIDOR



BAR ASSOCIATION

## CASE STUDY2

### SAKET DISTRICT COURT

#### CRITERIA OF SELECTION

1. Similar function
2. Similar climatic condition
3. Modern operational district court
4. Largest district court in India
5. Year of completion

#### .LOCATION

- SAKET, NEW DELHI
2. District court of south and south east district is located at Saket, New Delhi at Press Enclave Road near Pushp Vihar
  3. One can access to the district court by public mode of transport like metro (by alighting at Malviya Nagar, metro station) bus, auto taxi, etc

#### SITE DETAIL

1. SITE AREA - 68000 SQ MT
2. TOTAL BUILT-UP AREA - 106000 SQMT
3. PARKING- GROUND, UPPER BASEMENT LOWER BASEMENT
4. ECS - 1172 TOTAL ,  
373 - SURFACE  
799 - UNDERGROUND
5. GREEN COVER - 78% OF NON-BUILT UP AREA



#### CONCEPT AND FEATURES OF SAKET DISTRICT COURT

1. The basic design concept provides for the judges' chamber on a separate floor sandwiched between two court room floors.
2. The court complex has a separate administrative block.
3. Lower chamber block is an independent structure in the complex.
4. A separate utility block is made with all amenities.
5. At the present there are 81 court rooms out of which 68 are functional.
6. Family court is not a part of the complex.
7. Lockups for the prisoners are attached to the court block with a separate entry.
8. 128 residential houses for judicial officers.

**BUILT-UP STRUCTURE**

1. Located in saket , new delhi -110017 covering an area of 17 acres.
2. Centrally air conditioned
3. The judges chamber are located on 1st , 4th & 6th floor and the court rooms are located on ground , second , third , fifth and seventh floor
4. Each court is attached with an ahlmad room
5. CCTV cameras have been installed in the court premises.
- 6 At present there are 81 court court rooms available at saket court complex , out of which 68 court are functional



**FIRE SAFETY AND PROTECTION**

- UNDERGROUND WATER STORAGE TANK OF 2 LAKH LITRES CAPACITY
- ONE OVER HEAD WATER STORAGE TANK OF 20,000 LITRES CAPACITY
- FIRE LIFT
- WET RISER SYSTEM
- HOSE REEL
- HOSE BOX
- FIRE ALARM SYSTEM
- PORTAABLE FIRE EXTINGUISHER



**FACILITIES**

Ramps for handicapped  
 Seperate satirs and Lifts for judges  
 Two-level parking under advocate block  
 and admin block while single level parking  
 under court for public.

LIFTS - 11 for judges capacity - 6  
 06 for public capacity - 22  
 02 for advocate capacity-18

STAIRCASES - 9 for judges  
 6 for public  
 3 for advocates




# ADMIN BLOCK

- ◆ It is a seven storied building attached to the court block.
- ◆ Cash branch , nazrat branch, general , account, admin, offices
- ◆ computer branch, record room, RTI branch , care taking branch,
- ◆ copying agency
- ◆ Library for judges is on the first floor.



MAPPING

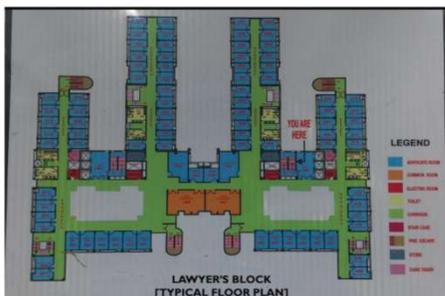


APPROXIMATE AREA - 3500SQMT  
 HEIGHT - 31.5M  
 NO.OF FLOORS - G+8  
 NO.OF LAWYER CHAMBER - 700 APPROX  
 86 PER FLOOR

CORE :

- ◆ STAIRCASES - 10 (INCLUDING 4 FIRE ESCAPE)
- ◆ LIFTS - 6
- ◆ TOILETS - 4 MEN  
- 4 WOMENS



LAWYER'S BLOCK

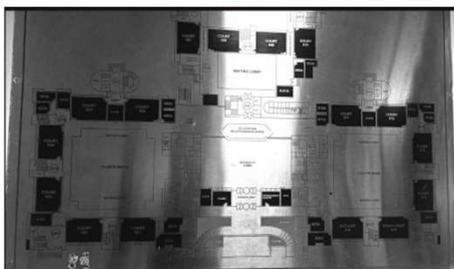

APPROXIMATE AREA - 8500 SQMT  
 HEIGHT - 31.5M  
 NO. OF FLOORS - G+8  
 -2 BASEMENTS  
 NO. OF COURT ROOMS - 16

CORE -

- ◆ STAIRCASES - 21
- ◆ LIFTS - 12
- ◆ TOILETS - 6 MEN  
-6 WOMEN
- ◆ ADMIN OFFICES - 6



INTERIOR VIEW FROM COURTROOM BUILDING

COURTROOMS PLUS JUDGE'S CHAMBER (GROUND FLOOR PLAN)



INTERIOR VIEW FROM COURTROOM BUILDING




COURTROOM BUILDING



INTERIOR VIEW FROM COURTROOM BUILDING

# JUDICIAL PROCEDURE :

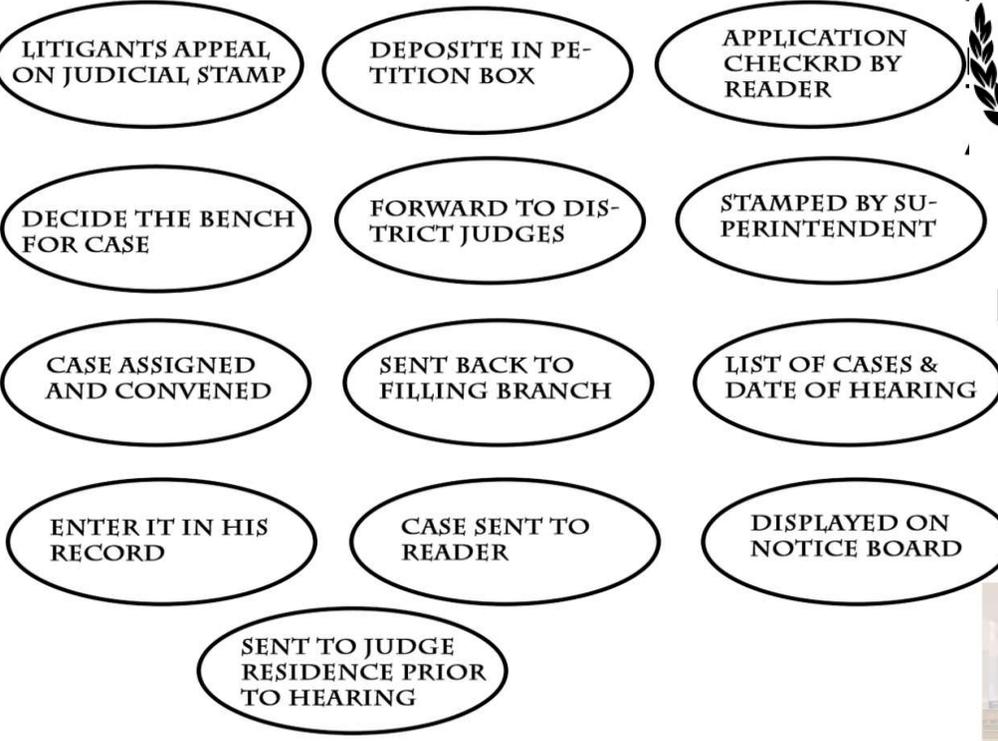

## FAMILY COURT

- ◆ Family court is an independent structure outside of the premises
- ◆ Special rooms have been provided keeping in view the basic needs of the childrens who come with their parents to attend the proceedings



FAMILY COURT AND ITS INTERIOR VIEW

## ADMIN BLOCK

- ◆ It is a seven storied building attached to the court block.
- ◆ Cash branch , nazrat branch,general ,account, admin,offices
- ◆ computer branch, record room, RTI branch , care taking branch,
- ◆ copying agency
- ◆ Library for judges is on the first floor.



Here are some photographs to show how the registries of courts are getting drowned in paper files:-

## ADVOCATE CHAMBER BLOCK

- ◆ 9 Storied building
- ◆ 700 rooms for advocate
- ◆ Ground floor has bar offices conferences room for 15 people,
- ◆ public and advocate canteen,kitchen and a store.
- ◆ Stamp vendors occupied the courtyard.
- ◆ Library and e-library is on the ground floor.
- ◆ Advocate chamber are made on upper floors with window A.C.



Photograph of the room where portfolios of electronic files are prepared



ADVOCATE CHAMBER



MEDITATION ROOM

## LOCATION

It is the district court of the south-west district. Located right next to the sector-10 metro station in the delhi suburb of dwarka. Approachable from two sides Surrounded by apartments on two side.

## ABOUT PROJECT :

NAME : DISTRICT COURT AT DWARKA, NEW DELHI-110045



CLIENT : Executive engineer,  
Building project division B-132  
Public works department (PWD)  
(GNC TD) PS Debri complex,  
New delhi - 110045

NATURE OF WORK : It is a multistorey building with basement, parking and ground+seven floors.It is a high tect building

PROJECT COST : Rs 217.00 crores

TOTAL BUILTUP : 1,08,586.00 Sqmt

DATE OF COMPLETION : 19-10-2008

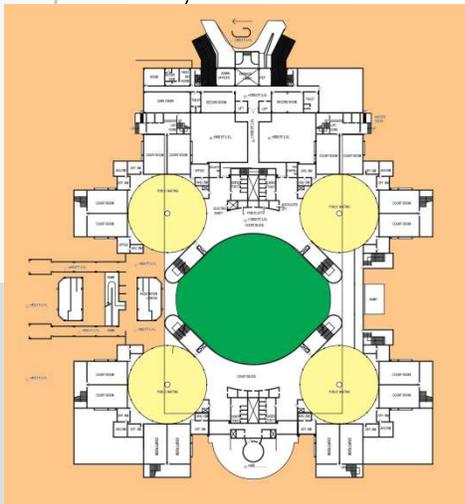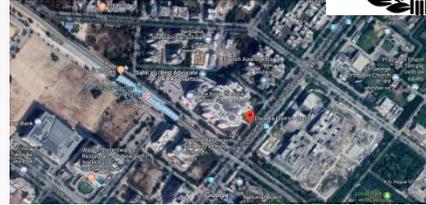

## CONCEPT AND FEATURES

The basic design concept provides for the judge's chamber on separate and exclusive floors sandwiched between two court room floors

Complex is a sensible blend of practically and the futuristic.

The court complex has a admin block connected to the court rooms at certain levels.

Lawyers Chambers Block is an independent structure in the complex

At present there are 64 court rooms available at Dwarka court complex.

Family court and meditation room and various other branches

Lookups for the prisoners is an independent units in the campus guarded by police.



## COURT BLOCK

The court block can be approached from 2 sides by the public and from one side by the lawyers. Front entrance is closed and not in use. The entrance leads to the courtyard.

It has seating built in stone with a truss over the top

The court block has four wings ABCD, with two in one block, connected by ramps and bridges on each floor.

Large waiting areas are provided in front of the court rooms for seating.

The two court building court buildings are connected by bridges and ramps on each floor with access on alternative floors for the public.

Family court has been set on the third floor in the 'A' and 'B' Wings. Special rooms have been provided keeping in view the basic needs of the children who come with their parents to attend the proceedings.



## ADVOCATE CHAMBER

It can be approached directly from the first floor for the advocates

Ground floor has public and advocate canteen, kitchen and store

A bank and post office is present for functioning

Library and e-library is on second floor  
Separate male and female toilets are present

A staircase and 2 lifts are provided from basement parking to the first floor.

Set of staircase and 3 lifts are provided.  
Male and female bar room is provided for advocates who come from other places

Bar room along with conference room is provided to attend the issues of advocates  
Advocate chamber is in upper floors



## LOCK ROOM

It is a two stories structure, covered with iron grill for extra security.

It has rooms with attached toilets .

Ventilation with grill are provided at a height of 2800mm

No.of windows is provided



## FACILITIES

Ramps for handicapped

Separate stairs and lifts for judges

4 staircases ,2m wide for public.

Less ventilation in staircases.

LIFTS- 06 for public capacity 18

04 for advocate capacity 10

Two level parking under advocates block

admin block while single -level parking

under court for public.



## CONSTRUCTION TECHNOLOGY

TRABEATED SYSTEM IS USED

USE OF MUSHROOM SLAB IN THE WAITING AREA

TRUSS ALSO FOR SEMICOVERING

MPROPER JOINERY BETWEEN WALLS AND COLUMNS

LOOKS UNPLEASANT

## SERVICES

Electrical supply-24X7 power supply backup by a generator.

Air conditioned courtroom, judges chamber were fully air conditioned.

Sewerage - disposal through sewer lines

Fire-fighting the building had good fire fighting system with

sprinklers placed all over at the distance of 3m fire

extinguishers placed near every court,

smoke detectors were also placed.

What I Learnt About The Legal Profession While Interning At The Dwarka Court Under An Advocate



# LITRATURE STUDY

## **HAIFA COURT HOUSE, ISRAEL**

### **INTRODUCTION**

HAIFA IS THE MAIN NORTHERN CITY OF ISRAEL, SITUATED ON THE SHORE OF THE MEDITERRANEAN SEA, ON THE SLOPS OF MOUNT CARMEL.

THE BUILDING SITE IS LOCATED AT HAIFA'S DOWNTOWN AREA, BETWEEN TWO ROADS THAT DEFINE ITS BOUNDARY. THE LOWER AVENUE SERVES AS A MAIN CITY THOROUGHFARE, LINKING THE CITY OF HAIFA TO THE NORTHERN PART OF ISRAEL.

THE TOPOGRAPHICAL SITUATION IS UNIQUE AS THE TOPOGRAPHICAL SOARING OF MOUNT CARMEL BEGINS AT THE SITE'S LONGITUDE PARALLEL.

THE BUILDING IS TREATED AS AN ORGANISED "LOW FACTORY"

**TYPE OF PROJECT:** LAW COURT

**LOCATION:** ISRAEL

**ARCHITECT:** CHYUTIN ARCHITECTS

**CLIENT:** HAFIA KHAN

**SITE AREA:** 12000 SQM.

**GROUND FLOOR AREA:** 9000 SQM.

**TOTAL BUILT UP:** 50000 SQM.

**FAR USED:** 400%

**HEIGHT:** 40 M.

**FLOOR COUNTS:** 11 NOS.

**NO. OF COURTROOM:** 73.

**PARKING:** 1300 CARS.

**YEAR:** 2015.



### **SITE LOCATION**

### **ROAD NETWORK**

THE HAFIA COURT, IN THE NORTHWESTERN FRENCH REGION OF NORMANDY, ARE LOCATED IN THE CITY CENTER.

**BOUNDRIES:**

**EAST:** OTHER PROPERTY

**WEST:** COMMERCIAL COMPLEX

**SOUTH:** ROAD

**NORTH:** ROAD



## FIGURE GROUND

THE FIGURE GROUND SHOWS A CLEAN INTENT OF THE ARCHITECT TO DESIGN A BUILDING WHICH SITES IN A GARDEN. THE SURROUNDING CONTEXT SHOWS A CONTRASTING PATTERNS WITH A MORE COARSE GRAINED AND FINE TEXTURED TYPOLOGY . THEY LACK CONSOLIDATED OPEN SPACE..



VIEW OF COURT



FIGURE GROUND



## CONNECTIVITY

THE ACCESSIBILITY TO THE COURT IS CLEAN AND SIMPLE . IT HAS TWO MAIN ROADS ABUTTING THE SITE ON THE NORTH AND SOUTH SIDE . THE SOUTH SIDE ROAD , RUE DUMONT AVENUE IS THE MAIN PUBLIC APPROACH ROAD AND THE NORTH ROAD , PIERRE BRETHLOT AVENUE PROVIDE THE SECURED ACCESS TO THE JUDGES . THE SURROUNDING CONTEXT IS PREDOMINANTLY SOCIO CULTURE . THIS RINGS THE COURT HOUSE RIGHT AMONGST THE PUBLIC REALM AND HELPS WITH THE RECONNECTION OF THE PUBLIC WITH THE JUDICIARY.

A PUBLIC LIBRARY IS ALSO A PART OF THE SAME PROJECT.

THE CAEN CANAL WHICH RUNS ALONG THE NORTH EDGE OF THE SITE IS A VENUE FOR THE ANNUAL ROWING COMPETITION AND OTHER WATER RELATED SOCIAL EVENTS .

THE COURTS BUILDING BECOMES A BACKDROPS FOR THESE EVENTS , THUS MAKING IT AN INSEPARABLE PART OF THE FESTIVITY.




## **SITE PLANNING**

- **A CONSOLIDATED BUILT BLOCK PROVIDES A SUITABLE RESPONSE TO A SMALL SITE.**
- **THE CENTRAL PUBLIC THOROUGHFARE CONNECTING THE EAST AND THE WEST PLAZAS IS THE MAIN FEATURE OF THE DESIGN.**
- **THE REAR END (NEAR SIDE ) IS RESERVED FOR THE SECURED ENTRY AND EXIT OF THE JUDGES.**
- **ITS CREATES AN ENCLOSED URBAN ENVIRONMENT WITHIN THE COURT BLOCK.**
- **BASEMENT PARKING HAS BEEN PROVIDED FOR ALL THE CARS COMING INTO THE SITE. THIS CAN HOWEVER POSE A SECURITY THREAT .**
- **THE PUBLIC THOROUGHFARE HAS THE COURTROOMS ON ONE SIDE AND THE ADMIN OFFICES ON THE OTHER .**
- **THE BUILDING SHOWS PROPER CLIMATIC RESPONSE IN THE WAY THAT THE LONGER WEST SIDE OF THE BUILDING CONSISTS OF VERY LESS OPENINGS. THIS REDUCES THE HEAT GAIN FOR THE BUILDING .**
- **ALSO, THE PUBLIC PLAZA FALLS ON THE MORE COMFORTABLE EAST SIDE.**

## **PLANNING**

### **INTERNAL PLANNING AND RELATIONSHIPS**

- **ALL INTERNAL PLANNING REVOLVES AROUND THE CENTRAL PUBLIC SPACE. IT IS DEVELOPED LIKE AN ENCLOSED URBAN PLAZA.**

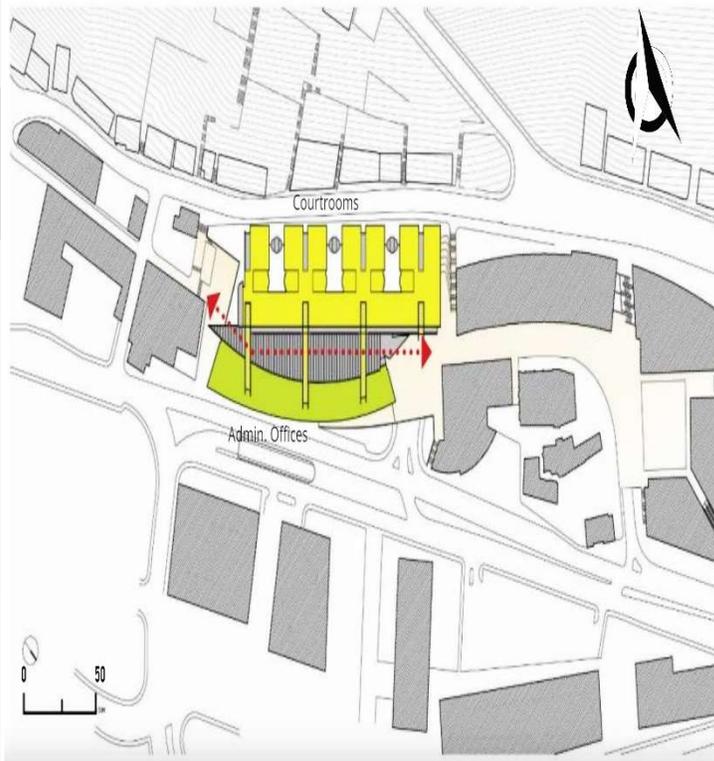


- ONE SIDE LIE THE COURTROOMS AND WAITING AREAS AND ON THE OTHER SIDE ARE THE ADMINISTRATIVE OFFICES.
- THE JUDGES' CHAMBERS LIE ON THE SUBORDINATE FLOORS ABOVE THE PUBLIC WAITING AREAS.
- CLOSE RELATIONSHIP BETWEEN THE JUDGES' CHAMBERS AND COURTROOM LOCK IS MAINTAINED IN ORDER TO SIMPLIFY CIRCULATION. HOWEVER, POINTS OF INTERSECTION BETWEEN THE TWO CIRCULATIONS CAN BE FOUND. THESE INTERSECTIONS CAN BE AVOIDED AND REGULATING PUBLIC MOVEMENT.

**SITE PLAN OF CAEN LAW COURT**

**JUDGE AREA**

**PUBLIC AREA**

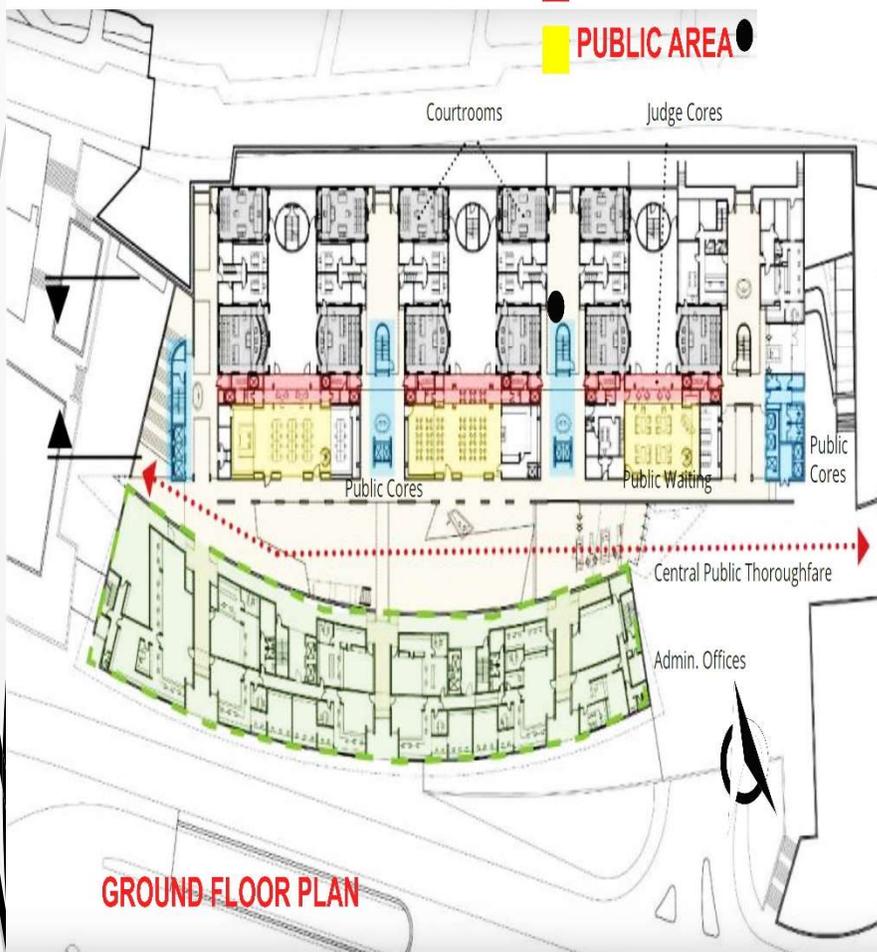


**GROUND FLOOR PLAN**

- JURY DELIBERATION ROOMS ARE PROVIDED BETWEEN A SET OF TWO COURTROOMS.

▼ FROM THE ENTRANCE HALL ONE ENTERS THE GENERAL SERVICE ACTIVITY AREA INCLUDING THE LAW LIBRARY, A RESTAURANT AND THE JUDGES' CLUB



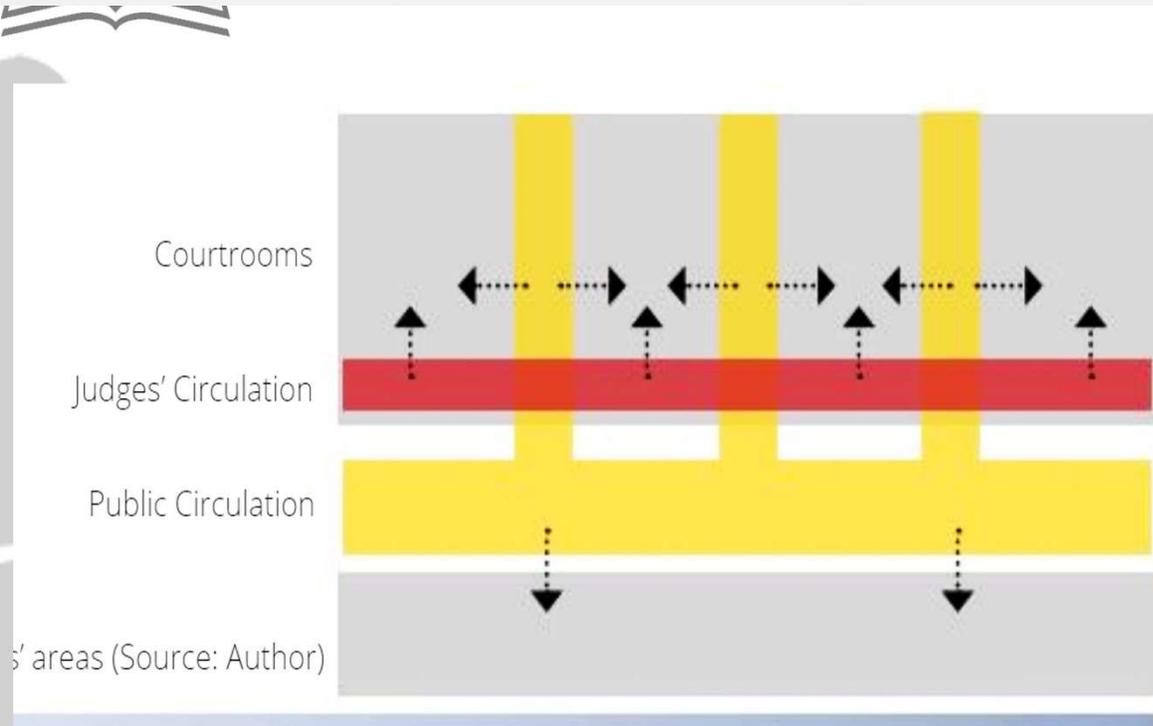

**RELATION BETWEEN PUBLIC AREA, COURTROOM & JUDGE AREA**


- PUBLIC AREA
- JUDGE AREA



**SECTION ACROSS THE COURTROOM AND BASEMENT**

THERE IS A MAJOR DIFFERENCE IN THE SCALE OF THIS PROJECT AND THE ONE AT HAND IN THIS THESIS . THERE IS ALSO A DIFFERENCE IN THE INSTITUTIONAL STRUCTURE OF BOTH THE COURT COMPLEXES. THE LACK OF ANY SORT OF LAWYERS BLOCK IS ONE OF THE MAJOR DIFFERENCES. HENCE THERE COULD BE NO STRONG LEARNINGS DERIVED IN THESE RESPECTS.

## SECTION OF COURT

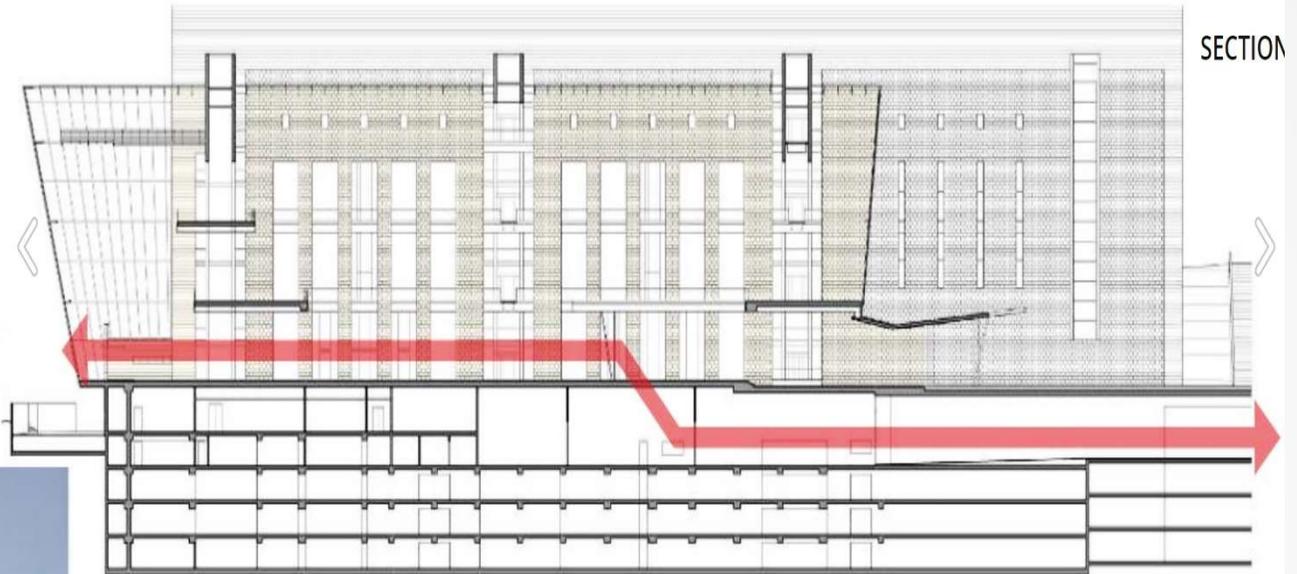

### SECTION BB'

THE BUILDING HAS BEEN FORESEEN AND DEVELOPED AS AN ABODE OF LIGHT. NATURAL LIGHT HAS BEEN ALLOWED TO PENETRATE INTO ALL OF THE COURTROOMS .

A FLUSH OF NATURAL LIGHT ON ONE OF THE SIDE WALLS OF THE COURTROOM PROVIDE A UN-NERVING EXPERIENCE IN THESE AREAS.

### CONCEPT:

THE BUILDING TRIES TO DEPICT THE CONCEPT OF A “GREEN BUILDING” & ENERGY CONSERVATION.

THE JUDGES LIBRARY AND THE CENTRAL PUBLIC PLAZA ALSO ENJOY SIMILAR WELL-LIT ENVIRONMENTS, GLASS ATRIUM AT BOTH ENDS DO THE TRICK.

THE HAIFA COURTHOUSE HAS A DISTINCT BRUTALIST ARCHITECTURAL EXPRESSION WHICH GOES WELL WITH THE FUNCTION. THE INTERIORS ARE CONTRASTINGLY WELL LIT



- MATERIALS USED ARE CONCRETE, GLASS, WOOD, METAL AND STONE CLADDING.



**SECTION BB**


## KEY LEARNING AND CONCLUSION

- MAJOR LEARNINGS FROM THIS CASE EXAMPLES REVOLVE AROUND THE ASPECTS OF ARCHITECTURAL EXPRESSION AND SYMBOLISM. THE LACK OF COHERENCE OF THE PROGRAM LIMITS ANY INFERENCES WHICH CAN BE DRAWN IN THE SUBJECT.
- SITE PLANNING HINTS TOWARDS HOW PUBLIC SPACE CAN BE INTERWOVEN WITH MORE RESTRICTIVE AND SECURED FUNCTIONS OF A COURTHOUSE. THE SIMPLICITY IN THE FORM AND ITS RELATIONSHIP WITH THE IDEA OF JURISDICTION IS ONE OF THE MAJOR DERIVATIVES FROM THE STUDY.

## LEARNING DIAGRAM:

CLIMATE

JUDGING BY THE ANALYSIS DIAGRAM, THE MAJOR CONTRIBUTIONS .

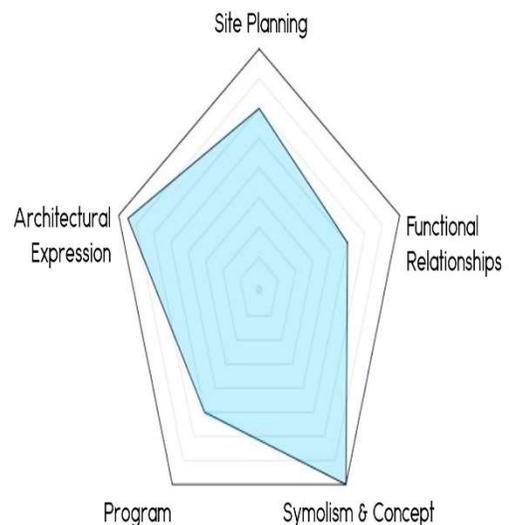




**PUBLIC ENTRANCE ATRIUM**



**THE PROTRUDING 4 FLOOR HIGH ATRIUM**

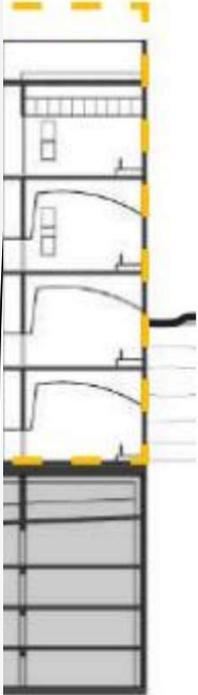

**COURT ROOM**



**JUDGE LIBRARY**

## CLIMATE

ISRAEL IS LOCATED, BETWEEN 29°-33° NORTH OF THE EQUATOR, WHICH IS CHARACTERIZED AS A SUBTROPICAL REGION, BETWEEN THE TEMPERATE ZONE AND THE TROPICAL ZONE. THE NORTHERN AND COASTAL REGIONS OF ISRAEL SHOW MEDITERRANEAN CLIMATE CHARACTERIZED BY HOT AND DRY SUMMERS AND COOL RAINY WINTERS. WHEREAS THE SOUTHERN AND EASTERN AREAS OF ISRAEL ARE CHARACTERIZED BY AN ARID CLIMATE. THE CITY OF EILAT, LOCATED AT THE SOUTHERNMOST POINT OF ISRAEL AND AT THE NORTHERN TIP OF RED SEA, HAS A GOOD CLIMATE FOR BEACH HOLIDAYS ALL YEAR ROUND

Functional Relationships

concept



# LITRATURE STUDY

## **CEAN LAW COURT, FRANCE**

### **INTRODUCTION**

THE CAEN LAW COURT IS LOCATED IN FRANCE. THE LAW COURT OF CAEN REDEFINES A NEW DOMAIN OF URBAN PLANNING IN THE CENTRE OF THE CITY. THE SHAPE OF THE BUILDING AGREES NOT ONLY WITH THE TRADITION BUT OF COURSE WITH THE MORE COMPLEX DUTIES OF LAW COURTS IN THE 21ST CENTURY. (ARCHDAILY, 2013) THE LAW COURTS AT CAEN ARE NOT EQUIVALENT TO A HIGH COURT, HENCE NOT MANY PROGRAMMATIC OR ORGANISATIONAL INFERENCES CAN DRAWN. HOWEVER, IT CAN INFORM ABOUT THE INTERPRETATION AND ARCHITECTURAL MANIFESTATION OF JUSTICE AND A COURTHOUSE IN CONTEMPORARY TIMES.

**TYPE OF PROJECT:** LAW COURT

**LOCATION:** FRANCE

**ARCHITECT:** BAUMSCHLAGER EBERLE

**CLIENT:** DAVID BASULTO

**SITE AREA:** 9000 SQM.

**GROUND FLOOR AREA:** 2100 SQM.

**TOTAL BUILT UP:** 9500 SQM.

**FAR USED:** 2100 SQM.

**HEIGHT:** 17.5 M.

**FLOOR COUNTS:** 5 NOS.


**NO. OF COURTROOM:** 6.

**PARKING:** 250 CARS.

**YEAR:** 2012.



**VIEW OF COURT**

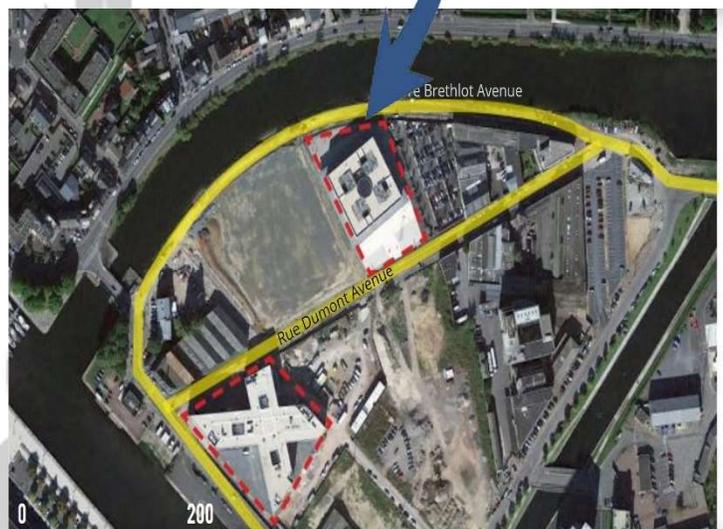

**ROAD NETWORK**

### **SITE LOCATION**

THE NEW LAW COURTS OF CAEN, IN THE NORTHWESTERN FRENCH REGION OF NORMANDY, ARE LOCATED IN THE CITY CENTER. **BOUNDRIES:**

**EAST:** OTHER PROPERTY

**WEST:** COMMERCIAL COMPLEX

**SOUTH:** ROAD

**NORTH:** ROAD

THE CAEN CANAL W IS A VENUE FOR THE WATER RELATED SO THE COURTS BUILDI THUS MAKING IT AN




## FIGURE GROUND

THE FIGURE GROUND SHOWS A CLEAN INTENT OF THE ARCHITECT TO DESIGN A BUILDING WHICH SITES IN A GARDEN. THE SURROUNDING CONTEXT SHOWS A CONTRASTING PATTERNS WITH A MORE COARSE GRAINED AND FINE TEXTURED TYPOLOGY . THEY LACK CONSOLIDATED OPEN SPACE..



VIEW OF COURT

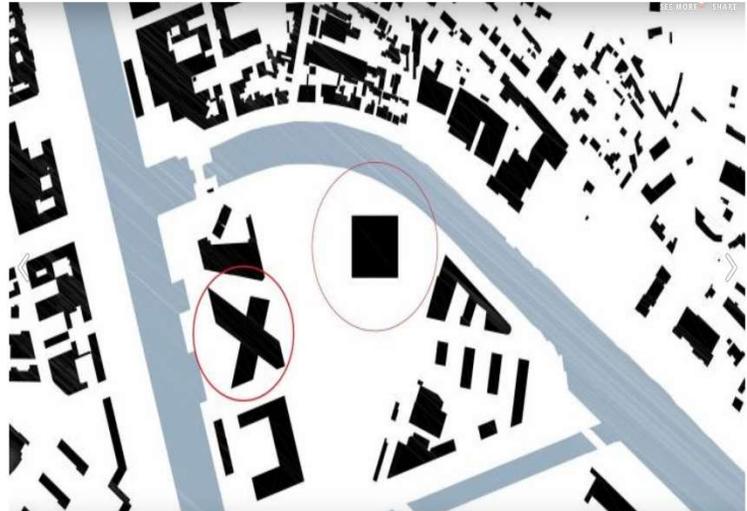

## CONNECTIVITY

## FIGURE GROUND

THE ACCESSIBILITY TO THE COURT IS CLEAN AND SIMPLE . IT HAS TWO MAIN ROADS ABUTTING THE SITE ON THE NORTH AND SOUTH SIDE . THE SOUTH SIDE ROAD , RUE DUMONT AVENUE IS THE MAIN PUBLIC APPROACH ROAD AND THE NORTH ROAD , PIERRE BRETHLOT AVENUE PROVIDE THE SECURED ACCESS TO THE JUDGES . THE SURROUNDING CONTEXT IS PREDOMINANTLY SOCIO CULTURE . THIS RINGS THE COURT HOUSE RIGHT AMONGST THE PUBLIC REALM AND HELPS WITH THE RECONNECTION OF THE PUBLIC WITH THE JUDICIARY.

A PUBLIC LIBRARY IS ALSO A PART OF THE SAME PROJECT.

THE CAEN CANAL WHICH RUNS ALONG THE NORTH EDGE OF THE SITE IS A VENUE FOR THE ANNUAL ROWING COMPETITION AND OTHER WATER RELATED SOCIAL EVENTS .

THE COURTS BUILDING BECOMES A BACKDROPS FOR THESE EVENTS , THUS MAKING IT AN INSEPARABLE PART OF THE FESTIVITY.



## SITE PLANNING

- DUE TO THE DESIGN DECISION TO KEEP ONE CONSOLIDATED LOCK FOR ALL THE FUNCTIONS ON THE COURT THE SITE PLANNING BECOMES SIMPLE AND EFFICIENT.
- THE FRONT EDGE OF THE SITE IS DEDICATED TO PUBLIC ENTRY, BOTH PEDESTRIAN AND VEHICULAR.
- THE REAR END (NEAR SIDE ) IS RESERVED FOR THE SECURED ENTRY AND EXIT OF THE JUDGES.
- THE INTERNAL FUNCTIONS TOO ARE ZONED ACCORDINGLY.
- ACCORDING TO THE HOLDING CAPACITY OF THE COURT , THE PUBLIC PARKING IS SUFFICIENT.
- JUDGE'S PARKING IS PROVIDED INSIDE THE BUILDING LOCK .
- THE PUBLIC AND JUDGE' S CIRCULATION BOTH ARE VERY SHORT AND DIRECT WHICH MAKES THEM MORE EFFICIENT . THE INTERNAL PLANNING CORRESPONDS TO THIS .
- ONE END OF THE SITE ALSO HAS A PUBLIC LIBRARY WHICH IS ALSO THE PART OF THE SAME PROJECT . THESE BLOCKS SHARE THE PUBLIC GREEN.

## PLANNING

### INTERNAL PLANNING AND RELATIONSHIPS

- AN ORTHOGONAL PATTERN CONSTITUTES THE BASE FOR THE INTERNAL ORGANISATION OF THE LAW COURT .




SITE PLAN OF CAEN LAW COURT



GROUND FLOOR PLAN



**SITE PLAN OF CAEN LAW COURT**

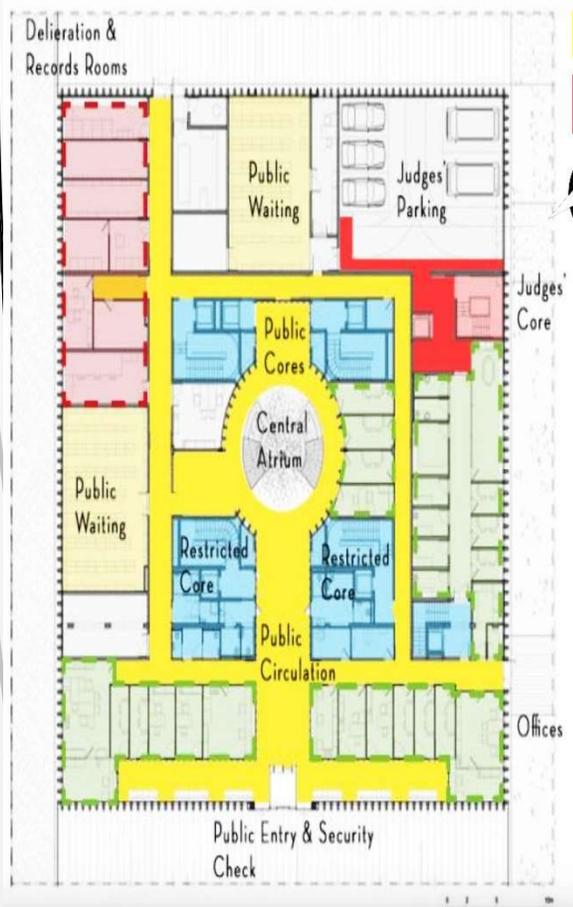

**PUBLIC AREA**  
**JUDGE AREA**




- THE MAN ROOMS ARE ADJACENT TO THE FACADES AND THE CORRIDORS THROUGHOUT THE BUILDING ALWAYS END UP AT THE FACADES , RESULTING
- FROM THE MAIN ENTRANCE THERE IS AN AXIS LEADING DIRECTLY TO THE MIDDLE OF THE BUILDING. THE CIRCULAR CENTER SPANS ALL 5 FLOORS AND IT IS THE HEART OF THE LAW
- DUE TO THE INSTITUTIONAL STRUCTURE OF THE JUDICIAL SYSTEM, THE JUDGES' CIRCULATION MIXES WITH THE JURY'S CIRCULATION AND HENCE CALLS FOR THE CREATION OF

● THE FIRST FLOOR IS MARKED BY THE PROTRUDING GLAZED HORIZONTAL BAND. THE FLOOR ACCOMMODATES THE TWO STOREY HIGH COURT ROOMS BUT IT IS ALSO SURROUNDED BY AN

● THE FIRST FLOOR IS MARKED BY THE PROTRUDING GLAZED HORIZONTAL BAND. THE FLOOR AT THE PASSIVE AND ACTIVE STRATEGIES ENSURE THE BUILDING TO ACHIEVE LOW ENERGY CONSUMPTION : A VERY COMPACT VOLUME, A DOUBLE SKIN FACADE SYSTEM AND A BIOCLIMATIC ATRIUM HELPS TO REDUCE HEAT LOSS WHILE INCREASING THERMAL INERTIA; GEOTHERMAL HEAT PUMP BRINGS BOTH HEATING AND COOLING BY USING RENEWABLE ENERGY. THE FLOOR ACCOMMODATES THE TWO STOREY HIGH COURT ROOMS BUT IT IS ALSO SURROUNDED BY AN EXTERNAL AND COMFORTABLE LAYER FOR THE ATTENDING AUDIENCE OF THE COURT.



**GROUND FLOOR PLAN**

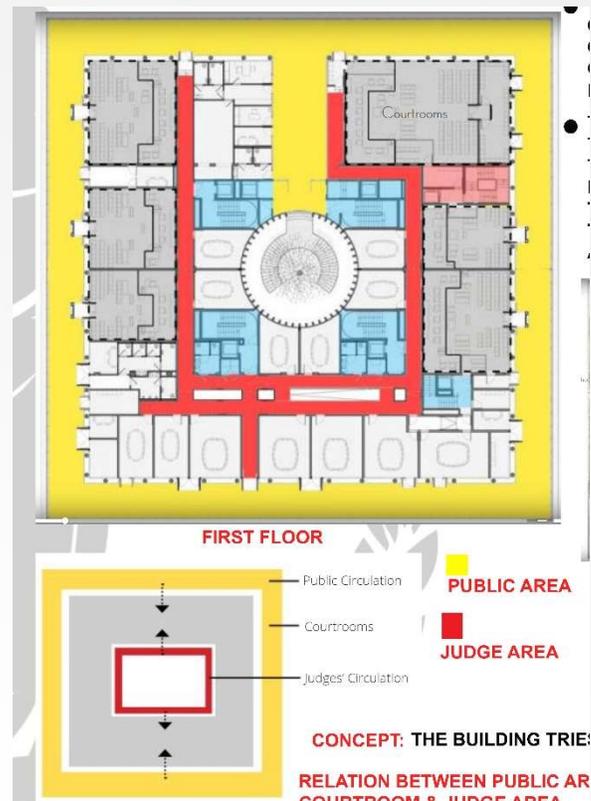

- THE PASSIVE AND ACTIVE STRATEGIES ENSURE THE BUILDING TO ACHIEVE LOW ENERGY CONSUMPTION : A VERY COMPACT VOLUME, A DOUBLE SKIN FACADE SYSTEM AND A BIO-CLIMATIC ATRIUM HELPS TO REDUCE HEAT LOSS WHILE INCREASING THERMAL INERTIA; GEOTHERMAL HEAT PUMP BRINGS BOTH HEATING AND COOLING BY USING RENEWABLE ENERGY.
- THERE IS A MAJOR DIFFERENCE IN THE SCALE OF THIS PROJECT AND THE ONE AT HAND IN THIS THESIS . THERE IS ALSO A DIFFERENCE IN THE INSTITUTIONAL STRUCTURE OF BOTH THE COURT COMPLEXES. THE LACK OF ANY SORT OF LAWYERS BLOCK IS ONE OF THE MAJOR DIFFERENCES. HENCE THERE COULD BE NO STRONG LEARNINGS DERIVED IN THESE RESPECTS.  
THE DIFFERENCE IN SCALE IS REFLECTED IN MANY OTHER FACETS AND HENCE BECOMES A MAJOR POINTS OF CONCERN BEFORE CONSIDERING ANY DESIGN MOVES.



## SYMBOLISM AND ARCHITECTURAL EXPRESSION

THE BUILDING HAS BEEN FORESEEN AND DEVELOPED AS AN ABODE OF LIGHT. NATURAL LIGHT HAS BEEN ALLOWED TO PENETRATE INTO ALL OF THE COURTROOMS .A FLUSH OF NATURAL LIGHT ON ONE OF THE SIDE WALLS OF THE COURTROOM PROVIDE A UN-NERVING EXPERIENCE IN THESE AREAS.

CONCEPT: THE BUILDING TRIES TO DEPICT THE CONCEPT OF A "GARDEN BUILDING" & ENERGY CONSERVATION.

RELATION BETWEEN PUBLIC AREA, COURTROOM & JUDGE AREA - A HORIZONTAL BAND HIGHLIGHTS THE FIRST FLOOR WHERE THE COURT ROOMS ARE LOCATED. IN SO DOING THIS NEW LAW COURTS



- A HORIZONTAL BAND HIGHLIGHTS THE FIRST FLOOR WHERE THE COURT ROOMS ARE LOCATED. IN SO DOING THIS NEW LAW COURTS COMMUNICATE A MESSAGE BOTH TO ITS USERS AND TO ON LOOKERS TRANSPERENCY AND BALANCE.
- A LARGE OPEN PUBLIC SPACE ON THE WESTERN SITE OF THE LOCK IS OF GREAT SIGNIFICANCE. IT MAINTAINS A SOCIAL CONNECTION BETWEEN THE COURT AND THE PEOPLE. IT MATERIALISES THE PAST IMAGE OF THE COURT WHEN PEOPLE USED TO RELATE TO THE COURT AND ITS FUNCTIONS AND USED ITS GREEN LAWNS TO PLAY AND RELAX.
- MATERIAL USED ARE CONCRETE, GLASS AND METAL. THE COURT ROOM ALSO SHOW SYMBOLIC IMAGERY DEPICTING JUSTICE, LAW AND THE INSTITUTE.
- THE MAIN ROOMS ARE ADJACENT TO THE FACADES; THE CORRIDORS THROUGHOUT THE BUILDING ALWAYS END AT THE FACADES. THIS RESULT IN GOOD LIGHTING, AND A COMFORTABLE WORKING AREA IS PROVIDED.



LE  
JUD  
ANA  
THE  
BUT

Architectural  
Expression

Program

- THE FLOOR ACCOMMODATES THE TWO STOREY HIGH COURT ROOMS BUT IT IS ALSO SURROUNDED BY AN EXTERNAL AND COMFORTABLE LAYER FOR THE ATTENDING AUDIENCE OF THE COURT. THIS LAYER IS COMPLETELY GLAZED AND PROVIDES A DIRECT VIEW TO THE ENTRANCES OF THE INTERIOR COURT ROOMS.


● THE NEW LAW COURTS OF CAEN IN NORTHERN FRANCE COMMUNICATE A MESSAGE TO ITS USERS AND PASSER-BYES: IT IS THE MESSAGE OF TRANSPARENCY, OF A STRINGENT SHAPE AND ESSENTIAL ARCHITECTURAL MEANS. THEREFORE IT IS NOT SO FAR AWAY FROM WHAT A EUROPEAN CIVILIZATION EXPECTS FROM JURISDICTION. BUT OUR CIVILIZATION TODAY EXPECTS EVEN MORE FROM A BUILDING – IT SHOULD SIMPLY ADD TO THE LONGEVITY OF OUR WORLD. THE BUILDINGS SUSTAINABLE STRATEGY AT CAEN IS DRIVEN BY TWO AXIS: THE PROJECT OFFERS BOTH HIGH COMFORT TO THE USERS AND OPTIMAL ENERGY PERFORMANCE.

● MATERIALS WERE SELECTED FOR THEIR SANITARY QUALITIES AND LOW IMPACT ON THE ENVIRONMENT. RAINWATER HARVESTING, NATURAL VENTILATION OF THE WAITING HALL AND A GLOBAL BIOCLIMATIC CONCEPTION ARE MANY ELEMENTS WHICH WILL HELP THE BUILDING TO REACH THIS SUSTAINABLE CHALLENGE.

## KEY LEARNING AND CONCLUSION

### LEARNING DIAGRAM:

IDENTIFYING BY THE ANALYSIS DIAGRAM, THE MAJOR CONTRIBUTIONS .

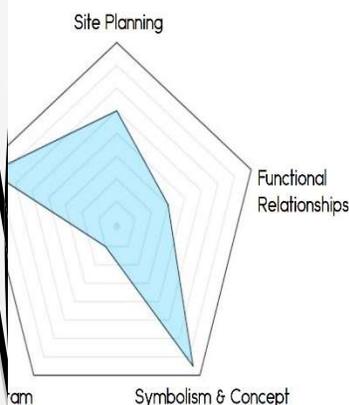

- MAJOR LEARNINGS FROM THIS CASE EXAMPLES REVOLVE AROUND THE ASPECTS OF ARCHITECTURAL EXPRESSION AND SYMBOLISM

- THE LACK OF COHERENCE OF THE PROGRAM LIMITS ANY INFERENCE WHICH CAN DRAWN IN THE SUBJECT.

- SITE PLANNING HINTS TOWARDS HOW PUBLIC SPACE CAN BE INTERWOVEN WITH MORE RESTRICTIVE AND SECURE FUNCTIONS OF A COURT HOUSE.

- THE SIMPLICITY IN THE FORM AND ITS RELATIONSHIP WITH THE IDEA OF JURISDICTION IS ONE OF THE MAJOR DERIVATIVES FROM THE STUDY.


- THE PRESENCE OF A PUBLIC LIBRARY WITHIN THE PRECINCT.



# COMPARISONS

	<b>CASE 1: SAKET DISTRICT COURT, DELHI</b>
SITE AREA	17 ACRES
YEAR	2010
TYPE OF BUILDING	DISTRICT COURT
ENTRANCE NO.	6 NOS.
NO. OF COURTS	64
AREA OF COURTROOM	92 SQM.
AREA OF COURT OFFICE	25 SQM.
HEIGHT OF EACH FLOOR	3.6 MT.
AREA OF WAITING AREA	270 SQM.
SITTING SPACE FOR PUBLIC	LANDSCAPED PARK IN FRONT OF COURT
PROVISION FOR HANDICAPS	RAMP FOR VERTICAL MOVEMENT & AT THE ENT.
PARKING	BASEMENT LEVEL 1
MADITATION CENTER	IN UTILITY BLOCK
FAMILY COURT	OUTSIDE THE CAMPUS
LOCKUPS AREA	800 SQM WITH GUARD ROOM
LAYWERS CHAMBERS	15 SQM.
AREA OF LIBRARY	800 SQM.
BAR ROOM	WITH CONFRENCE 15 SEATS
CANTEEN AREA	750 SQM / 200 ADV. & 300 PUB.
FIRE EXIT STAIRCASE	4 NOS. WITH 1500 MM WIDTH
UTILITY BLOCK AREA	2500 SQM
NO. OF LIFT IN COURT B.	JUDGE(11), PUBLIC(6), ADV.(2)
NO. OF STAIR CASE IN C.B	JUDGE(9), PUBLIC(6), ADV.(3)
RAMP & ITS GRADIENT	GRADIENT 110
MATERIAL	SAND-STONE & CLADDING
SITE PLANNING	

	<b>CASE 2: HIGH COURT, LUCKNOW</b>
SITE AREA	40 ACRES
YEAR	2016
TYPE OF BUILDING	HIGH COURT
ENTRANCE NO.	12 NOS.
NO. OF COURTS	84
AREA OF COURTROOM	162 SQM.
AREA OF COURT OFFICE	50 SQM.
HEIGHT OF EACH FLOOR	3.6 MT.
AREA OF WAITING AREA	400SQM.
SITTING SPACE FOR PUBLIC	LANDSCAPED PARK IN FRONT OF COURT
PROVISION FOR HANDICAPS	RAMP FOR VERTICAL MOVEMENT & AT THE ENT.
PARKING	BASEMENT LEVEL 1/ MULTI. PA.
MADITATION CENTER	IN UTILITY BLOCK
FAMILY COURT	INSIDE THE CAMPUS
LOCKUPS AREA	NO.
LAYWERS CHAMBERS	28 SQM.
AREA OF LIBRARY	2800 SQM.
BAR ROOM	WITH CONFRENCE 40 SEATS
CANTEEN AREA	800 SQM / 250 ADV. & 400 PUB.
FIRE EXIT STAIRCASE	4 NOS. WITH 1800 MM WIDTH
UTILITY BLOCK AREA	2500 SQM
NO. OF LIFT IN COURT B.)	JUDGE(11), PUBLIC(8), ADV.(4)
NO. OF STAIR CASE IN C.	JUDGE(10), PUBLIC(8), ADV.(6)
RAMP & ITS GRADIENT	GRADIENT 110
MATERIAL	SAND-STONE & CLADDING
SITE PLANNING	

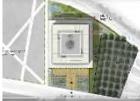	<b>LIT. 1: CAEN LAW COURT' FRANCE</b>
SITE AREA	10 ACRES
YEAR	2013
TYPE OF BUILDING	DISTRICT COURT
ENTRANCE NO.	5 NOS.
NO. OF COURTS	12
AREA OF COURTR	80 SQM.
AREA OF COURT C	23 SQM.
HEIGHT OF EACH F	3.0 MT.
AREA OF WAITING	230 SQM.
SITTING SPACE FO PUBLIC	LANDSCAPED PARK IN CENTER OF COURT
PROVISION FOR HANDICAPS	RAMP FOR VERTICAL MOVEMENT & AT THE ENT.
PARKING	SURFACE PARKING
MADITATION CENTI	IN A COURT
FAMILY COURT	INSIDE THE CAMPUS
LOCKUPS AREA	NO
LAYWERS CHAMBE	18 SQM.
AREA OF LIBRARY	500 SQM.
BAR ROOM	18 SEATS
CANTEEN AREA	550 SQM
FIRE EXIT STAIRCA	2 NOS. WITH 1500 MM WIDTH
UTILITY BLOCK AR	2800 SQM
NO. OF LIFT IN COL	JUDGE (3), PUBLIC(2), ADV.(2)
NO. OF STAIR CASI	JUDGE(2), PUBLIC(2), ADV.(2)
RAMP & ITS GRADI	GRADIENT 110
MATERIAL	FLY ASH BRICK & GLASS
SITE PLANNING	

	<b>LIT. 1: HAIFA COURT-HOUSE, ISRAEL</b>
SITE AREA	28 ACRES
YEAR	2015
TYPE OF BUILDING	HIGH COURT
ENTRANCE NO.	6 NOS.
NO. OF COURTS	53
AREA OF COURTR	84 SQM.
AREA OF COURT C	25 SQM.
HEIGHT OF EACH	3.6 MT.
AREA OF WAITING	270 SQM.
SITTING SPACE FC PUBLIC	LANDSCAPED PARK IN FRONT OF COURT
PROVISION FOR HANDICAPS	RAMP FOR VERTICAL MOVEMENT & AT THE ENT.
PARKING	BASEMENT LEVEL 1
MADITATION CENT	IN UTILITY BLOCK
FAMILY COURT	OUTSIDE THE CAMPUS
LOCKUPS AREA	NO
LAYWERS CHAMB	15 SQM.
AREA OF LIBRARY	800 SQM.
BAR ROOM	50 SEATS
CANTEEN AREA	600 SQM
FIRE EXIT STAIRCH	4 NOS
UTILITY BLOCK AF	2400 SQM
NO. OF LIFT IN CO(2)	JUDGE(8), PUBLIC(6), ADV.(2)
NO. OF STAIR CAS(2)	JUDGE(6), PUBLIC(3), ADV.(3)
RAMP & ITS GRADI	GRADIENT 110
MATERIAL	FLY ASH BRICK & CLDDING
SITE PLANNING	

# CONCEPT



## INTRODUCTION →

THE JUDICIAL DISTRICT COURT IS DISTRICT COURT. "LAW COURTS ARE SHELTERS OF LAW" COURT IS THE WORD WHICH DENOTES AN ENCLOSED SPACE. IT IS A TERM USED FOR JUDICIAL TRIBUNALS WHICH ORIGINALLY WERE ENCLOSED WITHIN WHICH JUDGES AND THEIR OFFICIALS WHILE THE COUNSEL ATTORNEYS AND THE GENERAL PUBLIC STOOD OUTSIDE THE BAR OF THE COURT.




## DESIGN

### MATERIALS

- GLASS FIBER REINFORCED CONCRETE
- GLASS FIBER REINFORCED CONCRETE BUILDING
- CONCRETE
- USES OF GLASS FIBER REINFORCED CONCRETE LIMITED BY SEVERE DAY AND NIGHT TEMPERATURE
- AGGREGATE
- GLASS IS TRANSPARENT
- IT PRESERVES GLASS
- STONE
- IT USES DEHRADUN

## SITE ANALYSIS →

**SITE LOCATION:** DEHRADUN IS LOCATED IN THE DOON VALLEY ON THE FOOTHILLS OF THE HIMALAYAS NESTED BETWEEN THE RIVER GANGES ON THE EAST AND THE RIVER YAMUNA ON THE WEST. THE DISTRICT COURT COMPLEX IS PROPOSED AT VILLAGE - UDDIWALA KARANPUR, PARGANA - CENTRAL DOON, HARIDWAR ROAD, TEHSIL 4 DISTRICT - DEHRADUN, UTTARAKHAND.

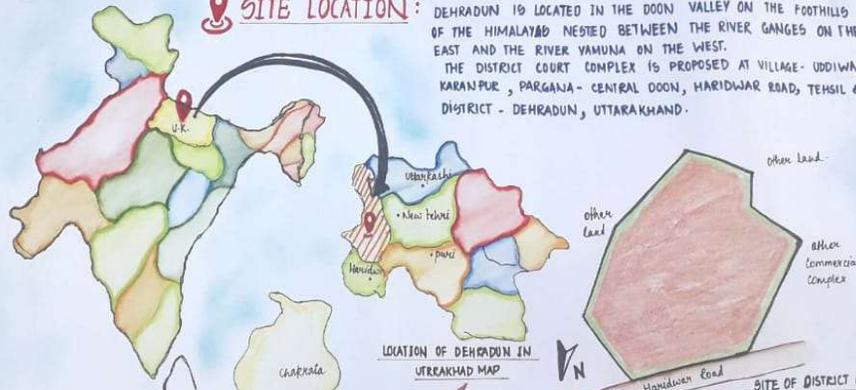

LOCATION OF UTTARAKHAND IN INDIA MAP

LOCATION OF DEHRADUN IN UTTARAKHAND MAP

### BOUNDARIES:


- EAST - OTHER GOVT. PROPERTY
- WEST - COMMERCIAL COMPLEX
- SOUTH - OTHER PROPERTY
- NORTH - HARIDWAR ROAD

### APPROACH OF THE PROJECT SITE :-

- NATIONAL HIGHWAY: NH 72 - 15 KM NORTH, NH 72A - 14 KM WEST
- AIRPORT: JOLY GRANT AIRPORT: 27 KM, SOUTH EAST
- RAILWAY STATION: DEHRADUN RAILWAY STATION: 750 M. WEST
- NEAREST TOWN/CITY: DEHRADUN - 4.0 KM
- RIVER BODY: GOWA RIVER: 7.1 KM, EAST
- NATIONAL PARK: RAJAJI NATIONAL PARK: 7.0 KM, SW
- STATE BOUNDARY: UP- UTTARAKHAND BORDER: 13 KM, SW
- SEISMICITY: THE STUDY AREA FALLS UNDER SEISMIC ZONE - IV

## CONCEPT → INTRODUCTION →

- THE SHIVLING CONSIST OF MAINLY THREE PARTS - LORD BRAHMA, LORD VISHNU, & LORD SHIVA, AS I SEGREGATE THESE 3 PARTS INTO 3 BLOCKS OF THE BUILDING.
- THE BASE OF THE SHIVLING IS LORD BRAHMA KNOWN AS THE CREATOR OF THE EARTH, HE FULFILL ALL THE UTILITIES & MADE US, SO YONI I IMPLEMENT THE ADMINISTRATION BLOCK & UTILITY BLOCK IN THIS PORTION SHOWING THAT THEY FULFILL ALL THE MADE OF COURT AND RECORDS EVERYTHING.
- THE MIDDLE OF THE SHIVLING IS LORD VISHNU WELL KNOWN AS THE PRESERVER, AS HE SAVES US FROM CALAMITIES OR PROBLEM. LAWYERS DOES THE SAME HE SAVE THE INNOCENT AND HELP IN MAKE THE JUSTICE

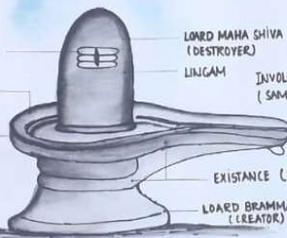


SHIVA LINGAM

DEHRADUN IS LOCATED IN THE DOON VALLEY ON THE FOOTHILLS OF THE HIMALAYAS NESTED BETWEEN OF THE HIMALAYAS RIVER GANGES ON THE EAST AND THE RIVER YAMUNA ON THE WEST. DOON OR DOON IS GARHWALI LANGUAGE REFERS TO A VALLEY THAT LIES BETWEEN THE MIDDLE HIMALAYAS AND THE 'SHIVALIKS'.

THE SHIVALIK HILLS, ALSO KNOWN AS CHURIA HILLS, ARE A MOUNTAIN RANGE OF THE OUTER HIMALAYAS THAT STRETCHES FROM THE INDUS RIVER ABOUT 3400KM (1500MI) EASTWARDS CLOSE TO THE BRAHMAPUTRA RIVER. 'SHIVALIK' LITERALLY MEANS 'TRESS OF SHIVA' WHICH

IMPLEMENT IN FORM OF BUILDING.

## CONCEPTUAL VIEWS →

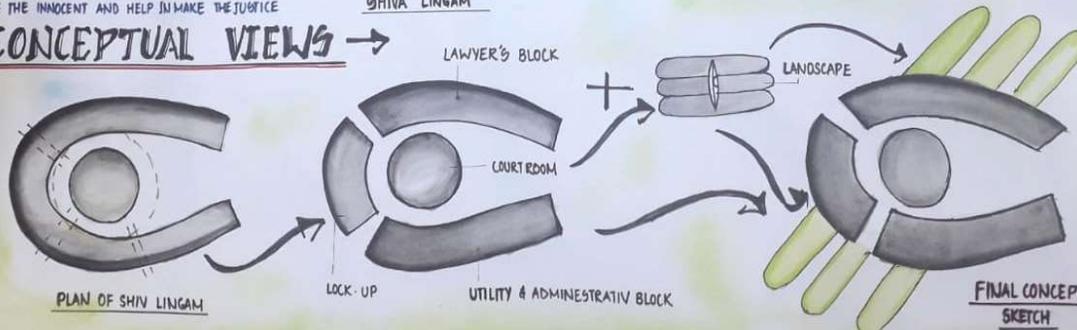

- SOFT I
- J T
- THE UP
- AND
- JOG
- CLP
- JUN
- ROG
- SHI
- TRI
- JU
- BA

# DESIGN CONSIDERATION →

## MATERIAL:

- GLASS FIBER REINFORCED CONCRETE IS A TYPE OF FIBER-REINFORCED CONCRETE. THE PRODUCT IS ALSO KNOWN AS GLASS FIBER REINFORCED CONCRETE IN BRITISH ENGLISH. GLASS FIBER CONCRETES ARE MAINLY USED IN EXTERIOR BUILDING, FACADE PANELS AND AS ARCHITECTURAL PRECAST CONCRETE.
- USES OF GLASS FIBER IN CONCRETE IS VERY LIMITED BECAUSE THEY SUFFER SEVERE DAMAGE AND LOSS OF STRENGTH DUE TO ABRASION AND IMPACT FORCES GENERATED DURING MOVEMENT OF AGGREGATES IN MIXER.
- GLASS IS USED IN BUILDING BECAUSE IT HARD SUBSTANCE WHICH MAY BE TRANSPARENT OR TRANSLUCENT AND BRITTLE IN NATURE ITS PROPERTIES ARE TRANSPARENCY, STRENGTH, WORKABILITY TRANSMITTANCE AND ITS U VALUE SHOULD HAVE LOWER, SO IT PRESENT THE AMOUNT OF HEAT TRANSFERRED THROUGH GLASS.
- STONE CLADDING USED IN INTERIOR OR EXTERIOR IN A BUILDING IT USE THIN LAYER OF STONE. ITS A LOCAL MATERIAL OF DEHRADUN. IT A LOWER WEIGHT AND HEIGT TRAP FOR BUILDING.



GLASS FIBER REINFORCED CONCRETE



STONE CLADDING WITH ALUMINIUM SECTION USED IN STRUCTURE.

## FACAD TREATMENT:



MAIN GATE ENTRANCE



MAIN ENTRANCE



FACAD OF LANDSCAPE

## ARCHITECTURE:

- MORDEN ARCHITECTURE USE IN BUILDING.
- MORENIST ARCHITECTURE WAS BASED UPON NEW AND INNOVATIVE TECHNOLOGIES OF CONSTRUCTION, PARTICULARLY THE USE OF GLASS, STEEL AND REINFORCED CONCRETE.
- THE IDEA THAT FORM SHOULD FOLLOW FUNCTION AN EMBRACE OF MINIMALISM AND A REJECTION OF ORNAMENT


## CLIMATE TREATMENT:

- DEHRADUN CLIMATE IS HUMID SUBTROPICAL.
- IN EAST: DIRECTION OF A BUILDING USED GLASS AND STONE CLADDING FOR HEAT TRAP.
- IN A SOUTH DIRECTION USED SMALL & SCRUBS VEGETATION FOR MAINTANE MICRO CLIMATE. AND LANDSCAPED OF SMALL GARDEN USED IN SOUTH DIRECTION.
- LUVERS USED IN BUILDING. HORIZONTAL LAYER USED FOR SHADE AND WIND MOVEMENT.



GARDEN IN FRONT OF SOUTH

GLASS & STONE CLADDING USED AT EAST

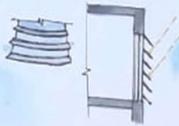

HORIZONTAL LOUVER.


## VEGETATION

- FILLO INFECTORIA (PAKUR)
- ATADIRKACHITHA INDICA (NEEM)
- PLUMERIA ALBA (TEMPLE TREE)




PAKUR ASHOK

# BUBBLE DIAGRAM →

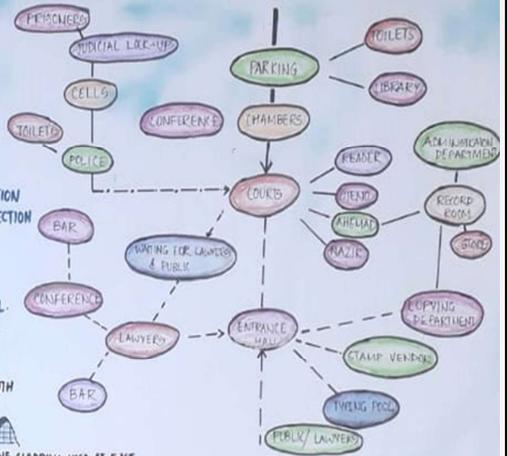

- CIRCULATION OF JUDGES
- PUBLIC
- LAWYERS
- PRISONERS
- STAFF

## BABBLE CHART OF DISTRICT COURT

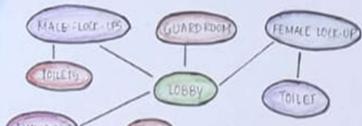

CIRCULATION OF PRISONERS UP TO LOCK-UPS

## BABBLE CHART OF PRISONER AREA

# FORM EVALUATION →

ST  
WEST  
SW



SHIVALIK - TRESS OF SHIVA



FORM OF TRESS WITH GANGA RIVER

LAWYER'S BLOCK

LOCK UP BLOCK

UTILITY BLOCK

SHIVALIK MEANS 'TRESS OF SHIVA' TRESS IMPLIMENT IN FROM OF COURT BUILDING AND LORD SHIVA RECEIVED GANGA IN HIS MATTED LOCKS (HAIR) AND RELEASED HER FROM HIS HAIR IN SEVEN STREAM AND THUS BECOME GANGADHARA. I DERIVED MY FORM OF THE BUILDING FROM THAT WAVES OF WATER AND HAIR. I DESIGNED THE BUILDING IN THE FORM OF TWAVES TO WHICH RESEMBLE TO LORD SHIVA.

## FINAL VIEW (FORM EVALUATION)



SO, I IMPLIMENT LAWYERS CHAMBER & LOCKUP IN THIS BLOCK.

THE UPPER PART I.E. LORD SHIVA KNOWN AS THE DESTROYER. HE DESTROYER THE EVIL AND SAVE INNOCENT ONE LIKE SAME JUDGE. IN THE COURT PUNISH THE CULPRIT AND PROVIDE JUSTICE TO INNOCENT SO, I IMPLIMENT COURT ROOM AND JUDGE CHAMBERS IN THIS BLOCK.

TRIPUNDRA TIKA SYMBOLS IMPLIMENT IN LANDSCAPE, WHICH PLACED SUBORDINATING OF COURT BUILDING.



# AREA ANALYSIS

SPACE	PLINTH AREA	AREA
COURT ROOMS	14.000 X 8.200	114.8
RETIRING ROOM	4.870 X 6.920	36.40
BATH ROOM	2.200 X 2.500	5.5
STENO ROOM	4.800 X 4.870	23.37
OFFICE ROOM 1	8.400 X 10.500	88.2
OFFICE ROOM 2	8.400 X 10.500	88.2
LIBRARY	10.185 X 14.495	145.58
RECORD ROOM (CIVIL)	42.383 X 21.780	924.71
RECORD ROOM (CRIMINAL)	18.110 X 41.194	747.27
CONFERENCE ROOM	16.780 X 17.300	291.61
COPYING SECTION	21.841 X 10.240	224.74
POLICE COPYING	9.055 X 7.430	67.6
STATIONARY AND FORM ROOM	4.000 X 5.500	22
NAZARAT	9.055 X 7.430	67.7
GOVERNMENT PLEADER ROOM (CIVIL CRIMINAL AND REVENUE)	5.500 X 3.645	20.05

SPACE	PLINTH AREA	AREA
MALKANA (CIVIL)	9.000 X 15.198	136.79
MALKANA (CRIMINAL)	9.000 X 14.198	130.59
STORE/GODOWN	9.000 X 7.500	67.5
INSPECTION/ENQUIRY CONTROL ROOM	5.570 X 3.600	20.05
S.A.O ROOM	3.950 X 3.185	12.5
MEETING ROOM	14.600 X 6.900	100.77
CASH SECTION	5.500 X 3.600	19.8
ACCOUNT SECTION	5.840 X 7.290	42.57
CANTEEN	12.00 X 18.920	224.8
COMPUTER ROOM	5.500 X 3.600	19.8
GENERATOR ROOM	21.841 X 10.290	224.74
LITIGANTS SHED	5.112 X 6.773	34.62
WITNESS SHED	5.112 X 6.773	34.62
INETERCOM/PBX ROOM	5.500 X 2.661	14.64
LOCKUP FOR GENTS	8.550 X 3.600	30.78
LOCKUP FOR LADIES	6.000 X 3.600	21.6
GARAGES	3.000 X 5.100	15.3

SPACES	PLINTH AREA	AREA
PUBLIC TOILETS (LAVATORY)	4.500 X 3.055	16.68
PUBLIC TOILETS (GENTS AND LADIES)	4.500 X 3.055	16.68
CYCLE – STAND	-	-
SCOOTER STAND	-	-
CAR - PARKING	-	-
OATH – COMMISSIONER ROOM	3.275 X 5.500	18
D.G.C ROOM (2)	5.500 X 3.600	19.8
GUARD ROOM	3.950 X 2.400	9.48
BANK	-	114
POST OFFICE	-	114.5
VEDIO- CONFERENCEING ROOM	5.500 X 3.600	19.8
CO – OPERATIVE CANTEEN	-	100.65
COURT MANAGER	4.000 X 3.270	13.08
A.D.R CENTER	-	351
DISPENSARY	5.560 X 3.296	18.33

PROVISIONS	PLINTH AREA	AREA
COURT ROOM	12.750 X 8.530	108.75
JUDGES CHAMBERS/ RETIRING ROOM	6.250 X 3.930 3.000 X 3.000	33.56
BATH ROOM	2.615 X 1.255	3.28
STENO – ROOM	3.020 X 4.370	13.19
OFFICE – ROOM	9.500 X 8.770	83.31
COUNSELING ROOM	3.040 X 5.040	15.22

# ***BIBLIOGRAPHY***

THE REFERENCE FOR THE THESIS HAS BEEN TAKEN FROM-

1- NEUFERTS

2-ARCH DAILY.COM


3-NATIONAL  
BUILDING CODE

4-GOOGLE.COM

5-PINTEREST

6-MINISTRY OF  
CULTURE



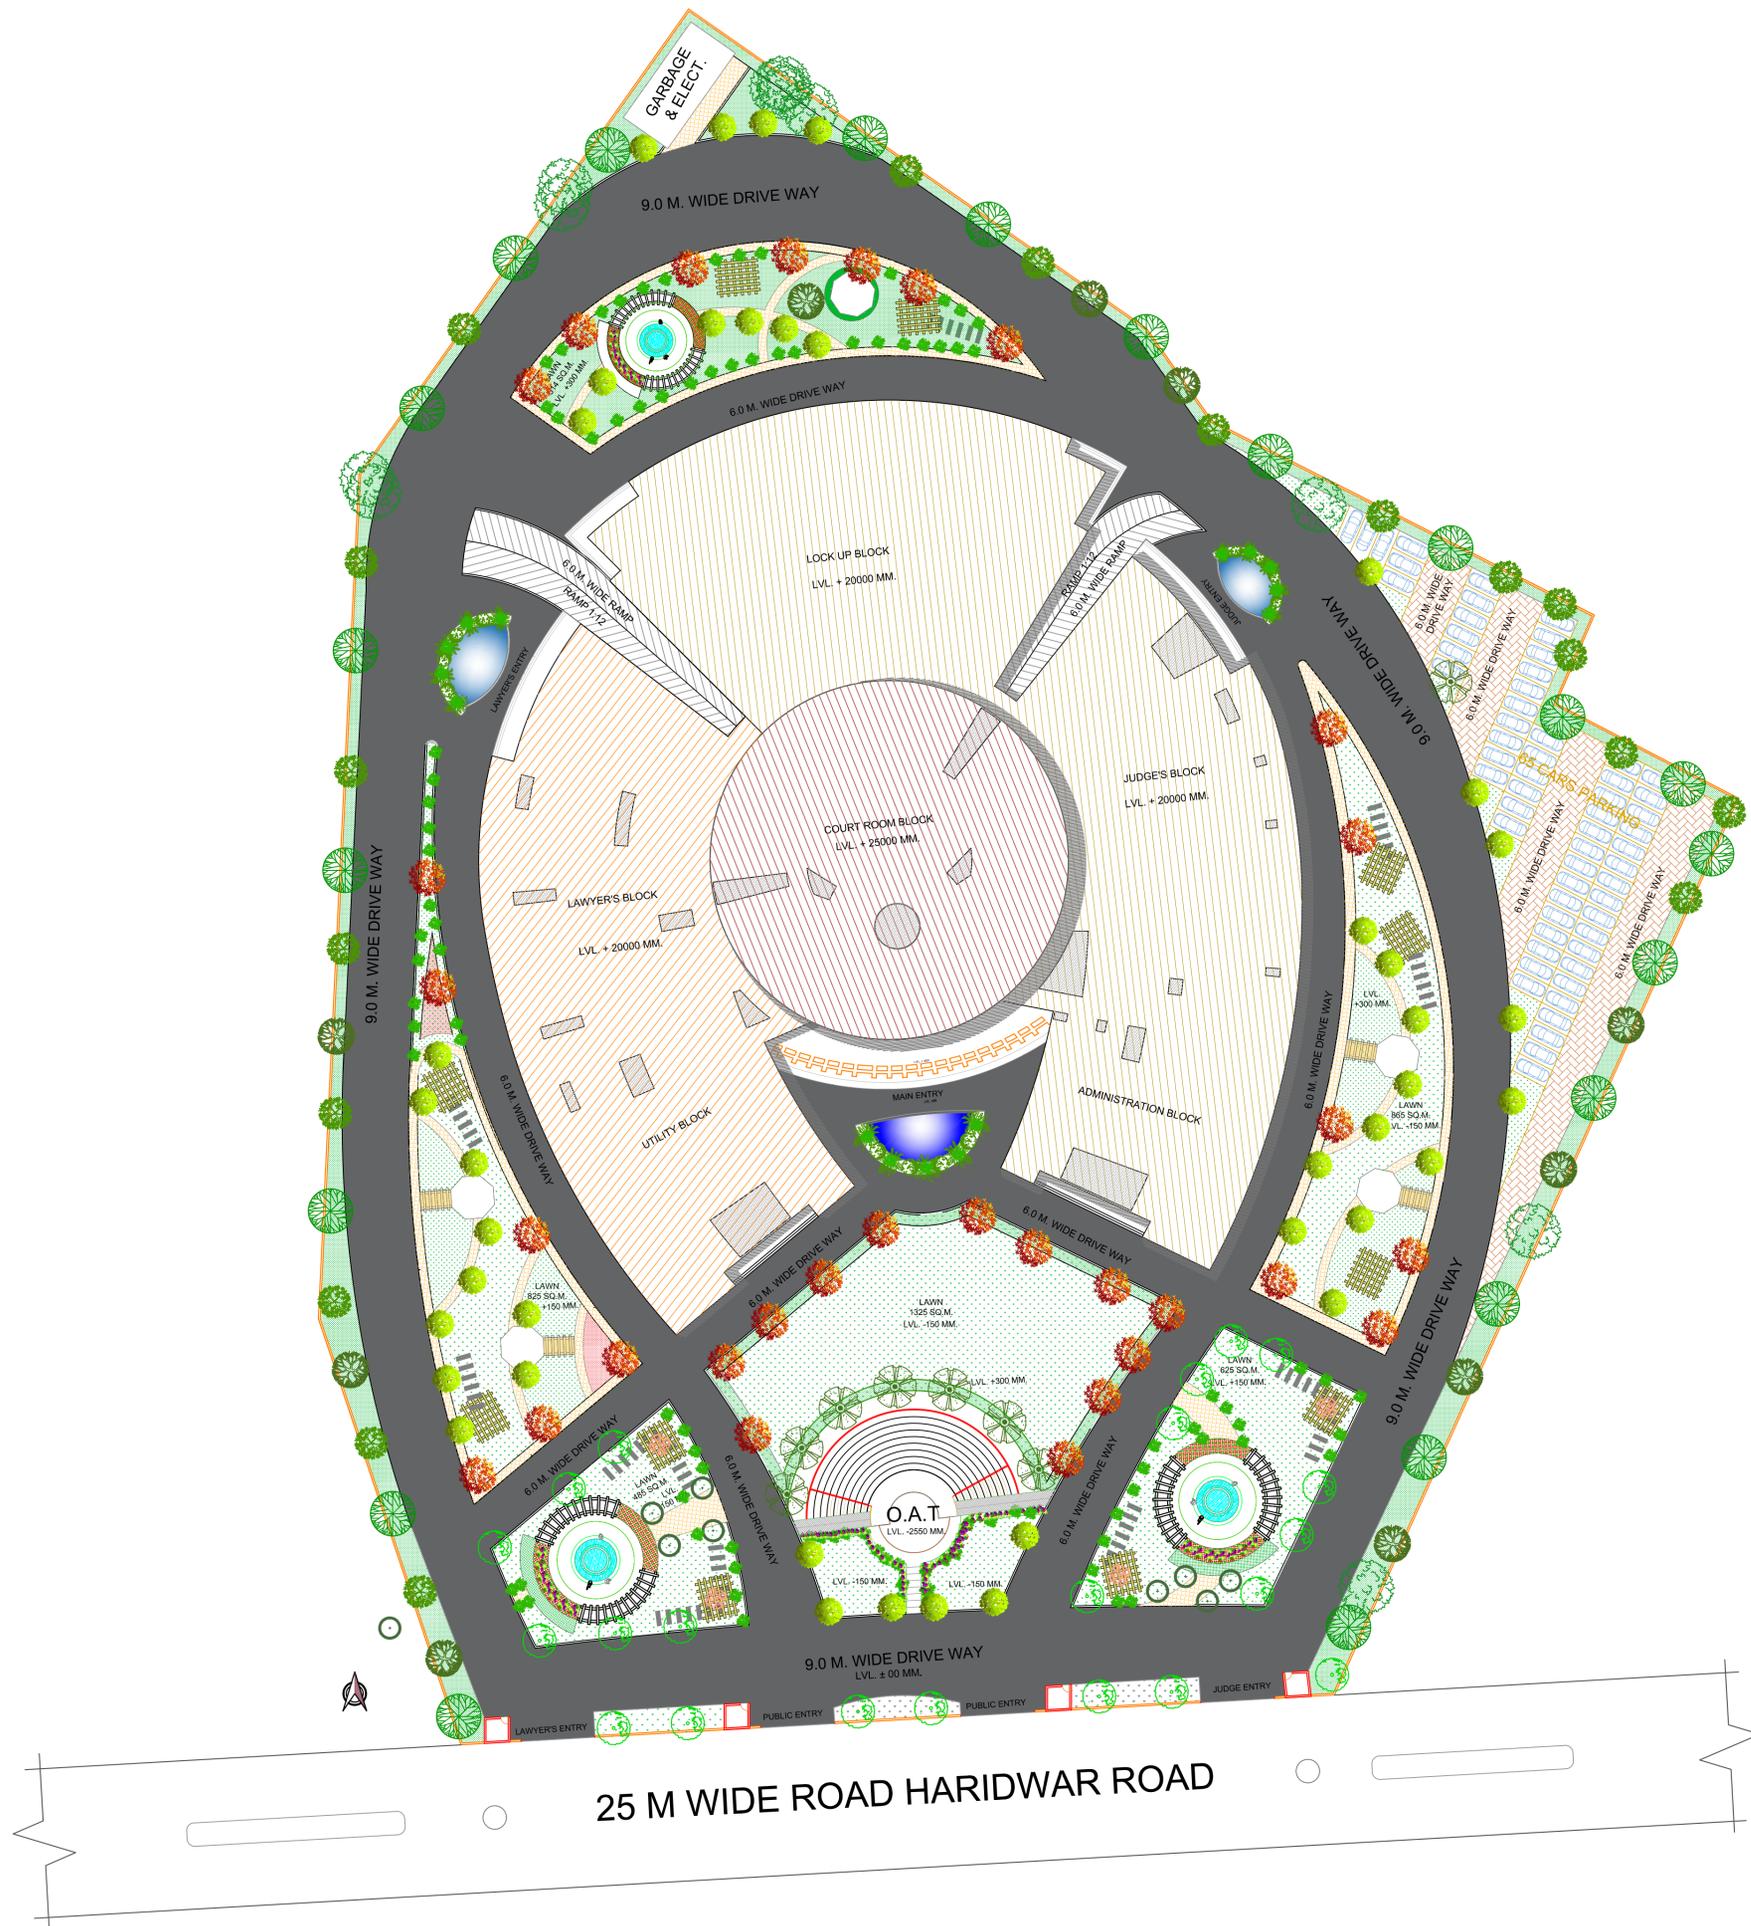

PROJECT TITLE

PROPOSED PLAN FOR  
'DISTRICT COURT COMPLEX  
AT DEHRADUN'




BYE LAWS :-  
SETBACKS

FRONT = 15.00 M. | G. COVERAGE ALLOWED = 35%  
REAR = 6.00 M. | F.A.R. ALLOWED = 1.50  
SIDE - 1 = 6.00 M.  
SIDE - 2 = 6.00 M.

AREA STATEMENTS :-

1. TOTAL PLOT AREA	= 26314.0 SQ. M. (= 6.30 ACRES)
2. PROPOSED COVERED AREA ON BASEMENT - 1 (SERVICES)	-- 9250.00 SQ.M.
3. PROPOSED COVERED AREA ON GROUND FLOOR	-- 7462.00 SQ.M.
4. PROPOSED COVERED AREA ON FIRST FLOOR	-- 7462.00 SQ.M.
5. PROPOSED COVERED AREA ON SECOND FLOOR	-- 7462.00 SQ.M.
6. PROPOSED COVERED AREA ON THIRD FLOOR	-- 7462.00 SQ.M.
7. PROP. COVD. AREA ON 4TH FL.	-- 7462.00 SQ.M.
8. TOTAL COVERED AREA (IN F.A.R. - 12.50)	= 29848.00 SQ.M.
9. OPEN AREA ON GROUND FLOOR	-- 3063.00 SQ.M.
10. AREA OF PORCH	-- 290.62 SQ.M.
11. GROUND COVERAGE	-- 28.36 %
12. GREEN AREA	-- 17.3%
13. PROPOSED TOTAL PARKING	-- 345 ECS
14. AREA REQUIRED FOR @ 32 SQM. PER ECS.--	10880 SQM
15.	

NORTH

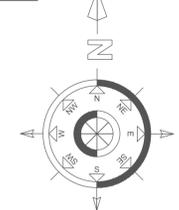

GENERAL NOTES

All Dimensions are in mm. or specified

SCALE

STUDENT DETAIL

Name - Poornima Raj Chaudhary  
Section - AR- 5-2  
Roll. No. - 1150101051

SHEET NO.

GUIDE DETAIL

PR. MOHIT AGARWAL & AR. RAMAKANT



PROJECT TITLE

PROPOSED PLAN FOR  
'DISTRICT COURT COMPLEX  
AT DEHRADUN'




BYE LAWS :-  
SETBACKS

FRONT = 15.00 M. G. COVERAGE ALLOWED = 35%  
REAR = 6.00 M. F.A.R. ALLOWED = 1.50  
SIDE - 1 = 6.00 M.  
SIDE - 2 = 6.00 M.

AREA STATEMENTS :-	
1. TOTAL PLOT AREA	= 26314.0 SQ. M. (= 6.30 ACRES)
2. PROPOSED COVERED AREA ON BASEMENT - 1 (SERVICES)	-- 9250.00 SQ.M.
3. PROPOSED COVERED AREA ON GROUND FLOOR	-- 7462.00 SQ.M.
4. PROPOSED COVERED AREA ON FIRST FLOOR	-- 7462.00 SQ.M.
5. PROPOSED COVERED AREA ON SECOND FLOOR	-- 7462.00 SQ.M.
6. PROPOSED COVERED AREA ON THIRD FLOOR	-- 7462.00 SQ.M.
7. PROP. COVD. AREA ON 4TH FL.	-- 7462.00 SQ.M.
8. PROP. COVD. AREA ON 5TH FL.	-- 53.00 SQ.M.
9. (IN F.A.R. - 12.50)	= 29901.00 SQ.M.
10. OPEN AREA ON GROUND FLOOR	-- 3063.00 SQ.M.
11. AREA OF PORCH	-- 290.62 SQ.M.
12. GROUND COVERAGE	-- 28.36 %
13. GREEN AREA	-- 17.3%
14. PROPOSED TOTAL PARKING	-- 345 ECS
15. AREA REQUIRED FOR @ 32 SQM. PER ECS. --	10880 SQM

NORTH

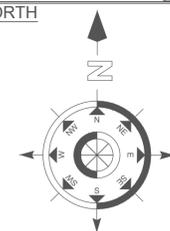

GENERAL NOTES

All Dimensions are in mm. or specified

SCALE


STUDENT DETAIL

Name - Poornima Raj Chaudhary  
Section - AR- 5-2  
Roll. No. - 1150101051

SHEET NO.

GUIDE DETAIL

PR. MOHIT AGARWAL & AR. RAMAKANT

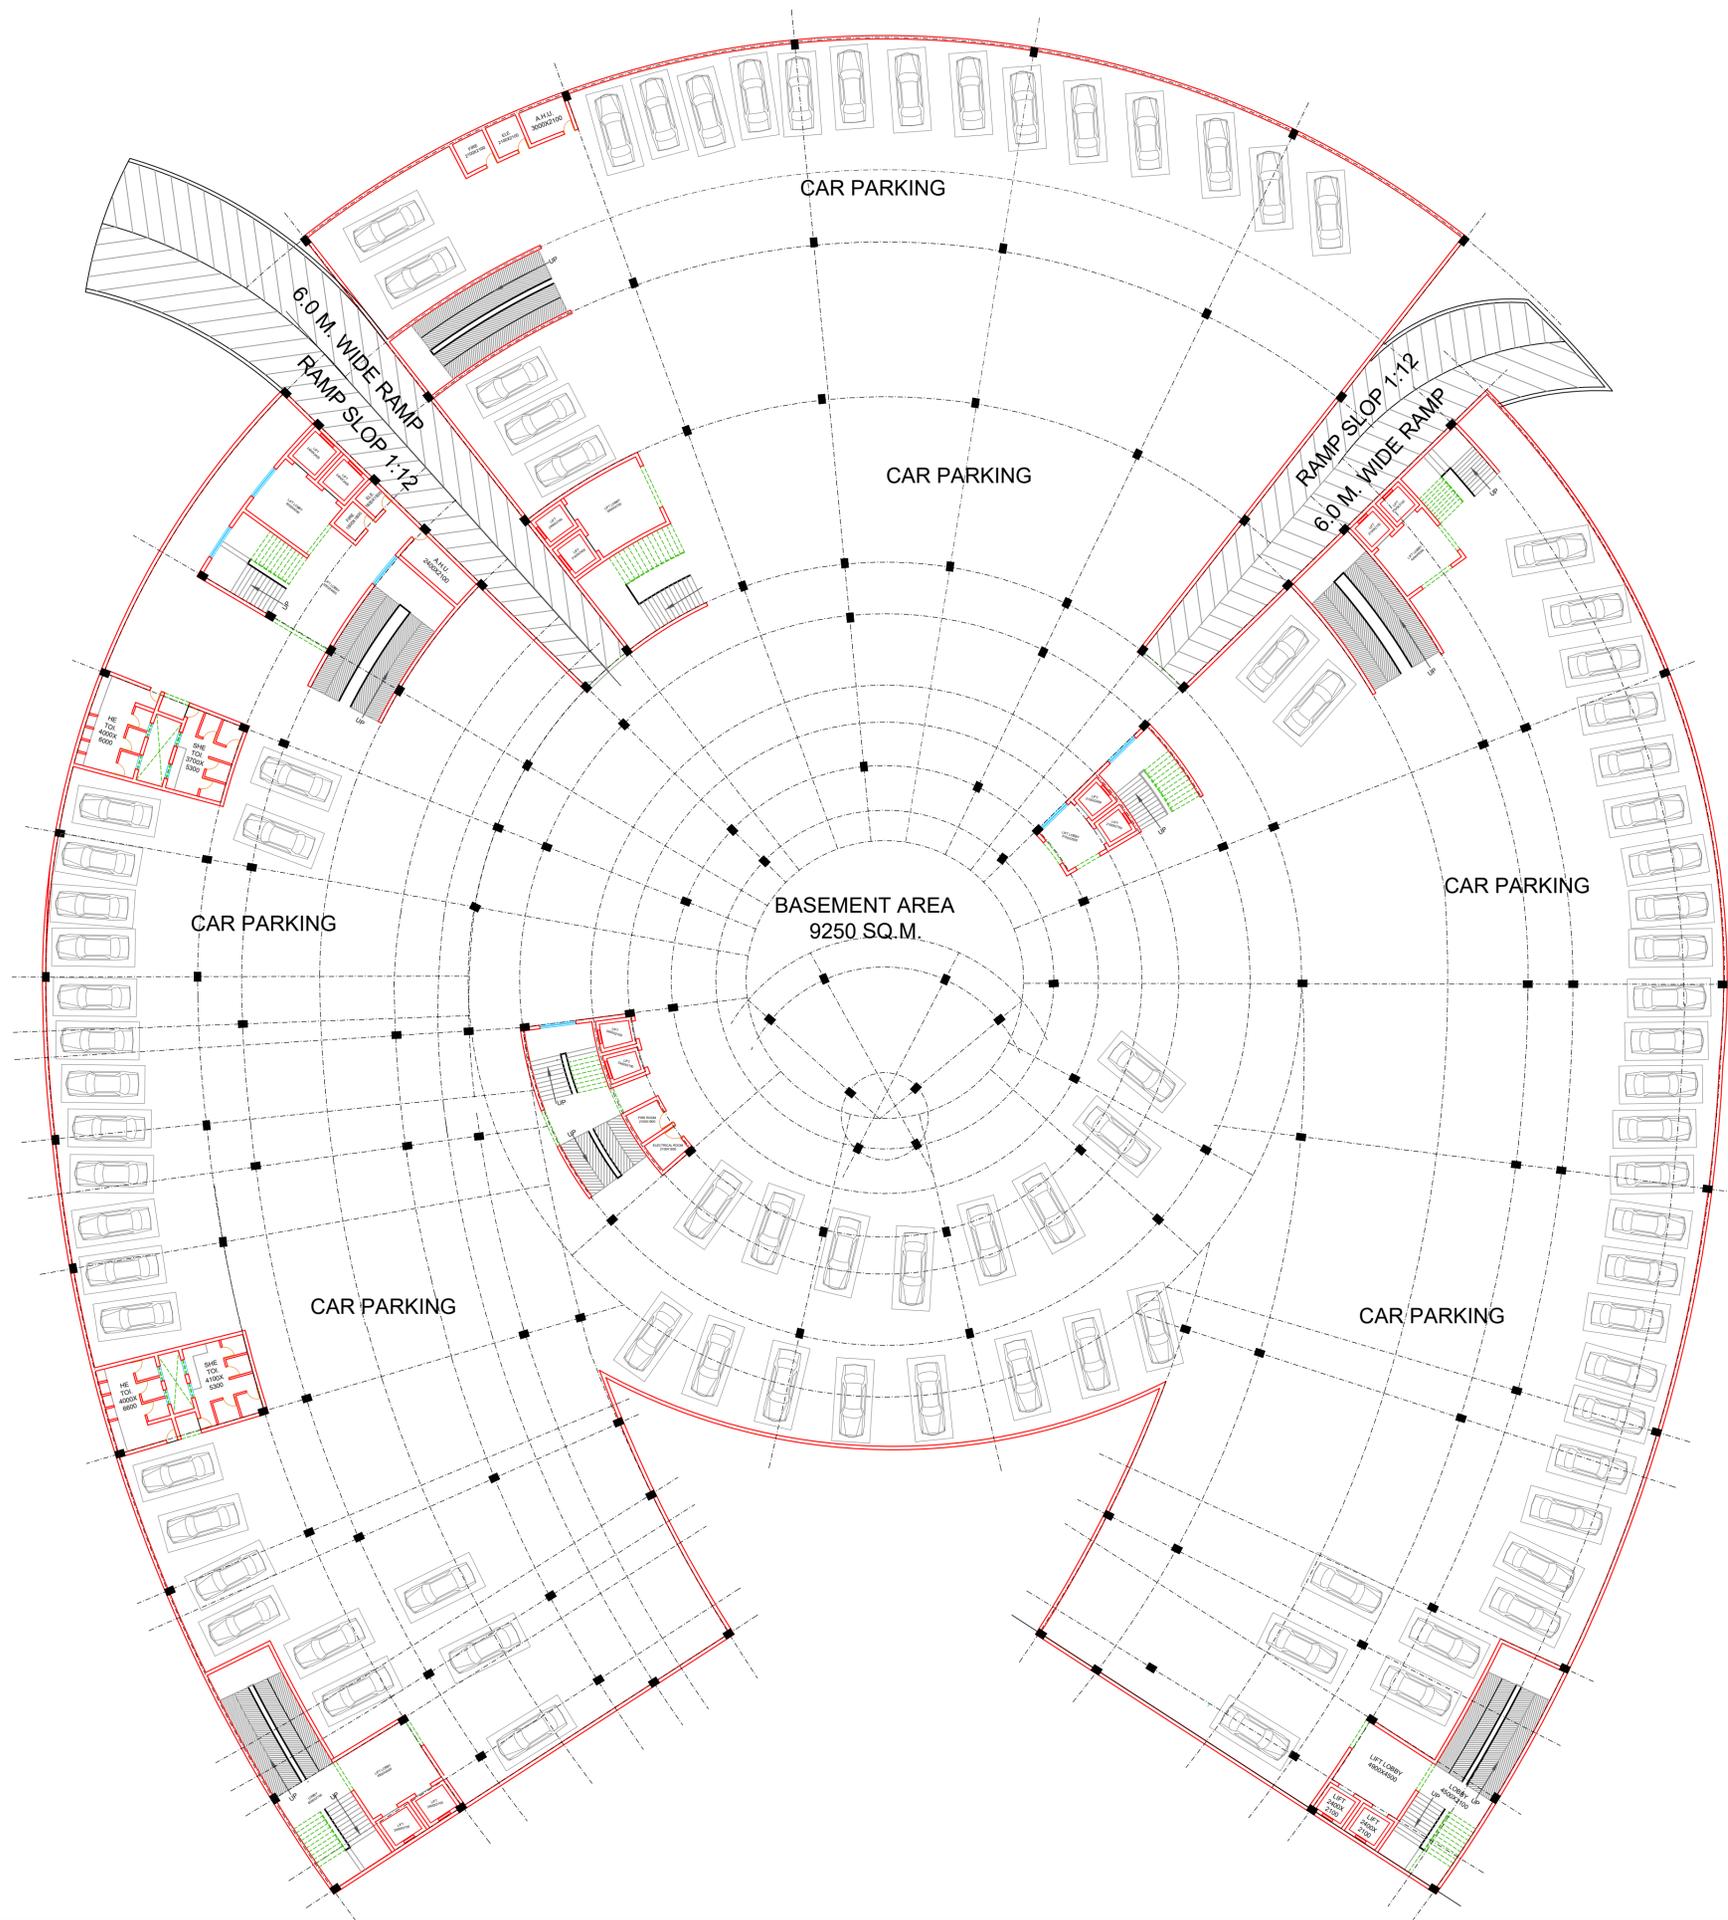

BASEMENT FLOOR PLAN



PROJECT TITLE

PROPOSED PLAN FOR  
'DISTRICT COURT COMPLEX  
AT DEHRADUN'



BYE LAWS :-


SETBACKS

FRONT = 15.00 M. G. COVERAGE ALLOWED = 35%  
 REAR = 6.00 M. F.A.R. ALLOWED = 1.50  
 SIDE - 1 = 6.00 M.  
 SIDE - 2 = 6.00 M.

AREA STATEMENTS :-

1. TOTAL PLOT AREA	= 26314.0 SQ. M. (= 6.30 ACRES)
2. PROPOSED COVERED AREA ON BASEMENT - 1 (SERVICES)	-- 9250.00 SQ.M.
3. PROPOSED COVERED AREA ON GROUND FLOOR	-- 7462.00 SQ.M.
4. PROPOSED COVERED AREA ON FIRST FLOOR	-- 7462.00 SQ.M.
5. PROPOSED COVERED AREA ON SECOND FLOOR	-- 7462.00 SQ.M.
6. PROPOSED COVERED AREA ON THIRD FLOOR	-- 7462.00 SQ.M.
7. PROP. COVD. AREA ON 4TH FL.	-- 7462.00 SQ.M.
8. PROP. COVD. AREA ON 5TH FL.	-- 53.00 SQ.M.
9. TOTAL COVERED AREA (IN F.A.R. - 12.50)	= 29901.00 SQ.M.
10. OPEN AREA ON GROUND FLOOR	-- 3063.00 SQ.M.
11. AREA OF PORCH	-- 290.62 SQ.M.
12. GROUND COVERAGE	-- 28.36 %
13. GREEN AREA	-- 17.3%
14. PROPOSED TOTAL PARKING	-- 345 ECS
15. AREA REQUIRED FOR @ 32 SQM. PER ECS.	-- 10880 SQM

NORTH

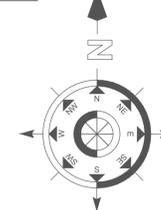

GENERAL NOTES

All Dimensions are in mm. or specified

SCALE


STUDENT DETAIL

Name - Poornima Raj Chaudhary  
 Section - AR- 5-2  
 Roll. No. - 1150101051

SHEET NO.

GUIDE DETAIL

PR. MOHIT AGARWAL & AR. RAMAKANT

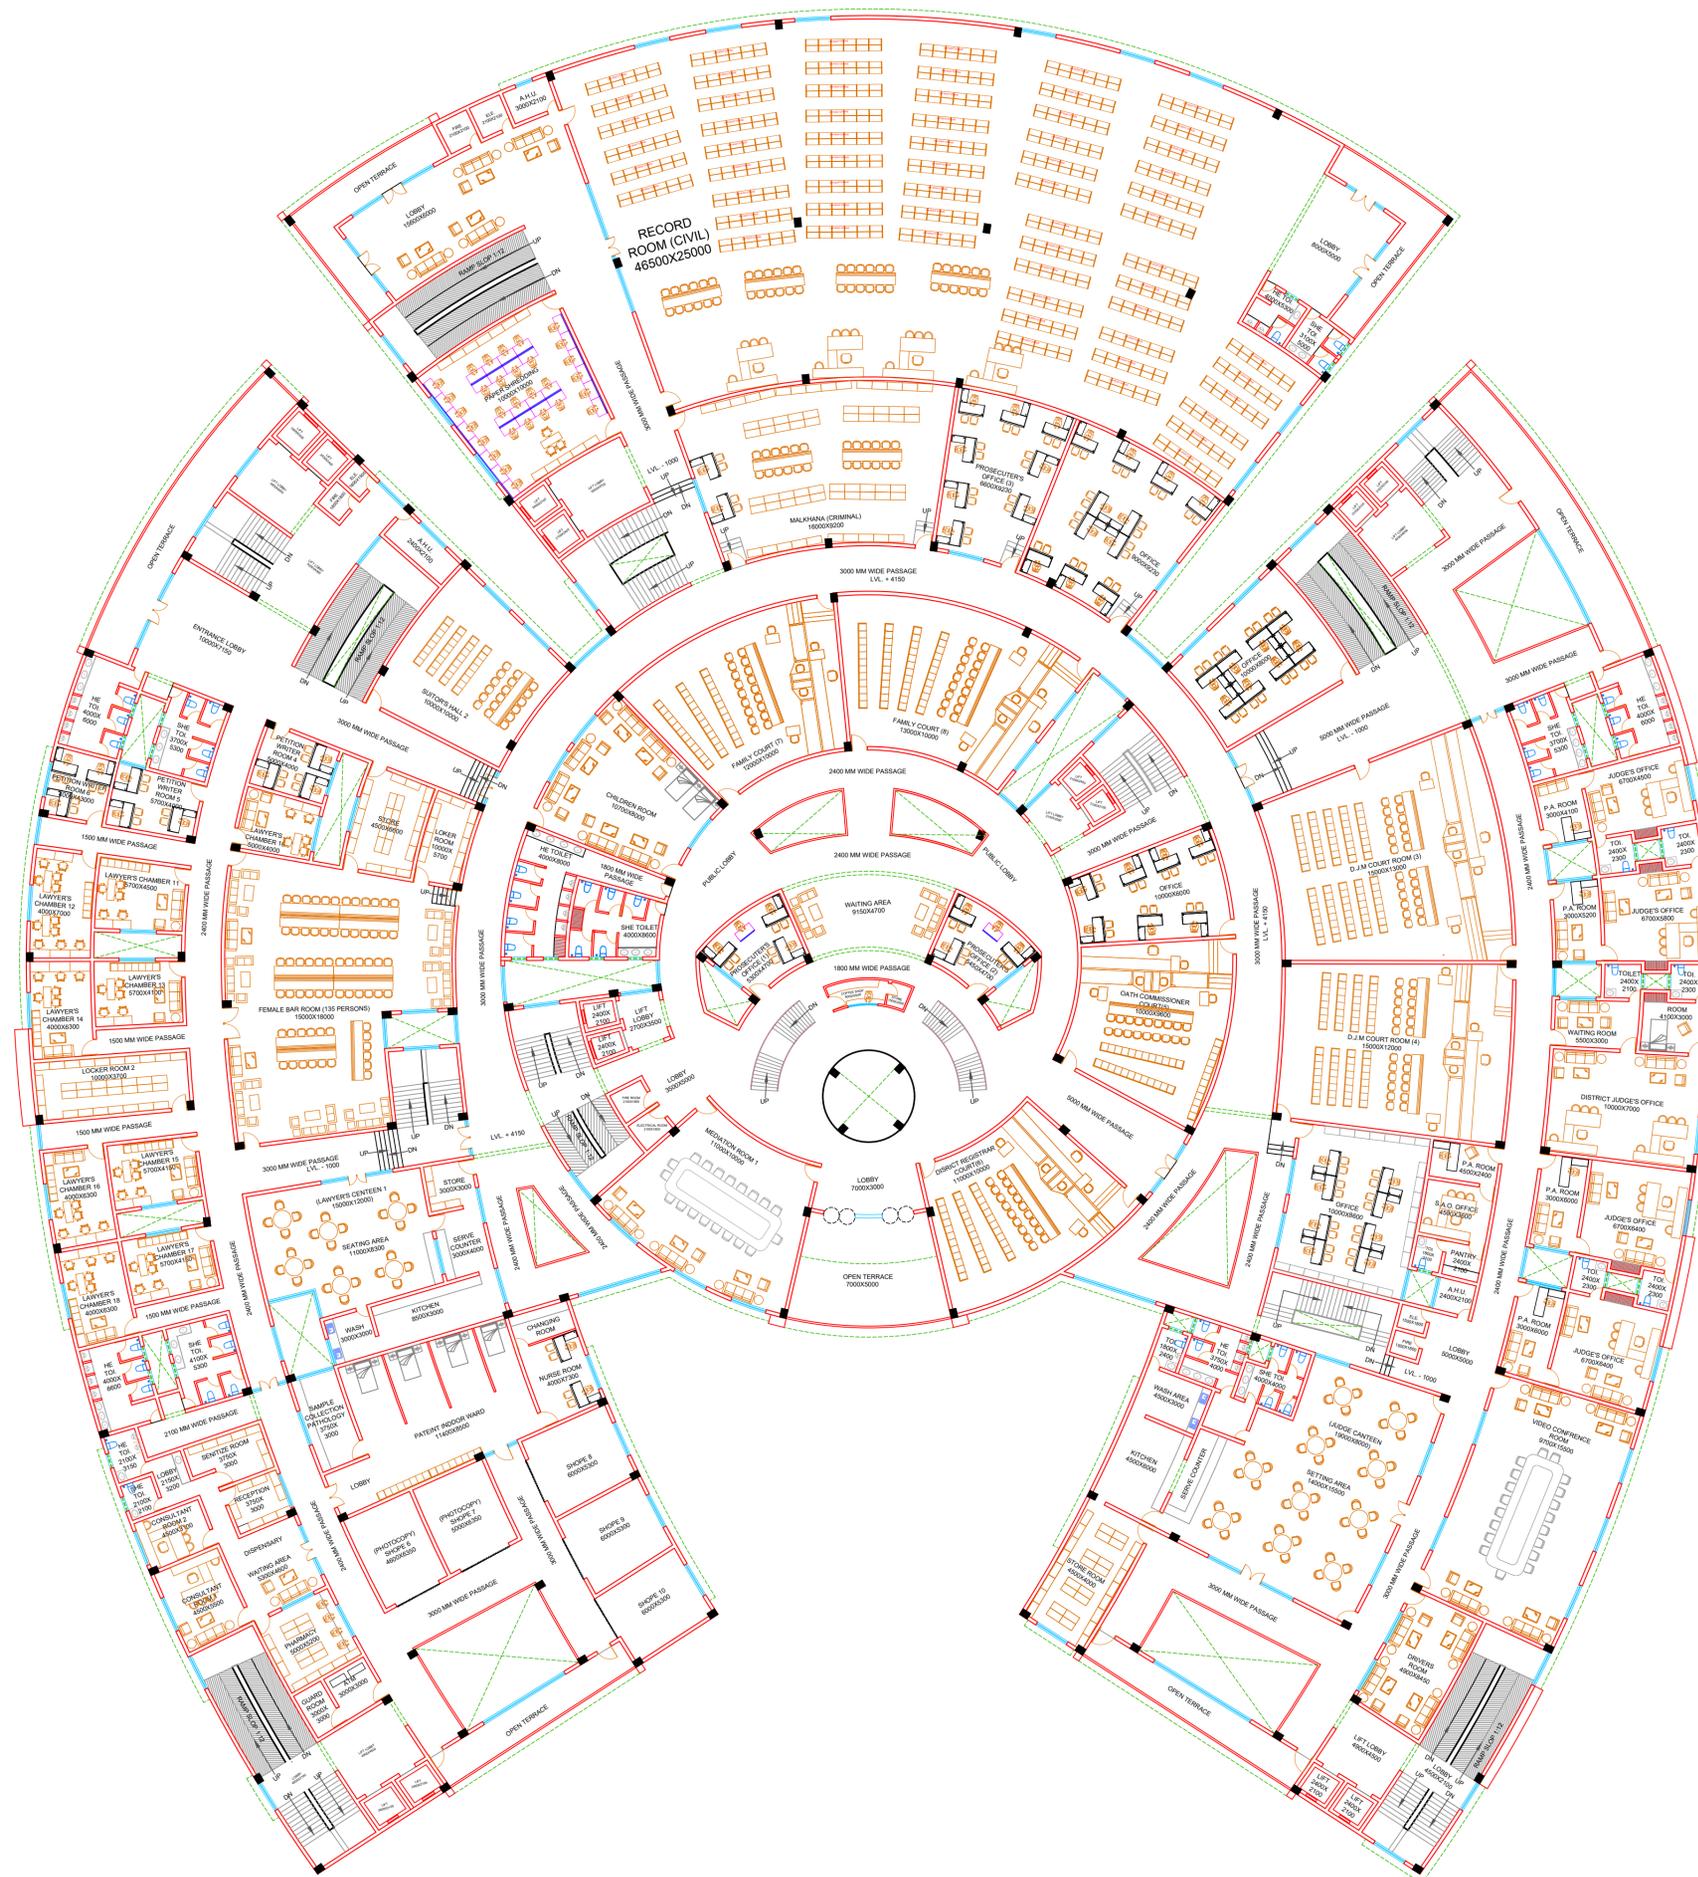

FIRST FLOOR PLAN



PROJECT TITLE

PROPOSED PLAN FOR  
'DISTRICT COURT COMPLEX  
AT DEHRADUN'



BYE LAWS :-  
SETBACKS  
FRONT = 15.00 M. | G. COVERAGE ALLOWED = 35%  
REAR = 6.00 M. | F.A.R. ALLOWED = 1.50  
SIDE - 1 = 6.00 M.  
SIDE - 2 = 6.00 M.

AREA STATEMENTS :-	
1. TOTAL PLOT AREA	= 26314.0 SQ. M. (= 6.30 ACRES)
2. PROPOSED COVERED AREA ON BASEMENT - 1 (SERVICES)	-- 9250.00 SQ.M.
3. PROPOSED COVERED AREA ON GROUND FLOOR	-- 7462.00 SQ.M.
4. PROPOSED COVERED AREA ON FIRST FLOOR	-- 7462.00 SQ.M.
5. PROPOSED COVERED AREA ON SECOND FLOOR	-- 7462.00 SQ.M.
6. PROPOSED COVERED AREA ON THIRD FLOOR	-- 7462.00 SQ.M.
7. PROP. COVD. AREA ON 4TH FL.	-- 7462.00 SQ.M.
8. PROP. COVD. AREA ON 5TH FL.	-- 53.00 SQ.M.
9. TOTAL COVERED AREA (IN F.A.R. - 12.50)	= 29901.00 SQ.M.
10. OPEN AREA ON GROUND FLOOR	-- 3063.00 SQ.M.
11. AREA OF PORCH	-- 290.62 SQ.M.
12. GROUND COVERAGE	-- 28.36 %
13. GREEN AREA	-- 17.3%
14. PROPOSED TOTAL PARKING	-- 345 ECS
15. AREA REQUIRED FOR @ 32 SQM. PER ECS.	-- 10880 SQM

**GENERAL NOTES**


All Dimensions are in mm. or specified

**SCALE**

**STUDENT DETAIL**  
Name - Poornima Raj  
Chaudhary  
Section - AR- 5-2  
Roll. No. - 1150101051

**SHEET NO.**

**GUIDE DETAIL**  
PR. MOHIT AGARWAL  
&  
AR. RAMAKANT

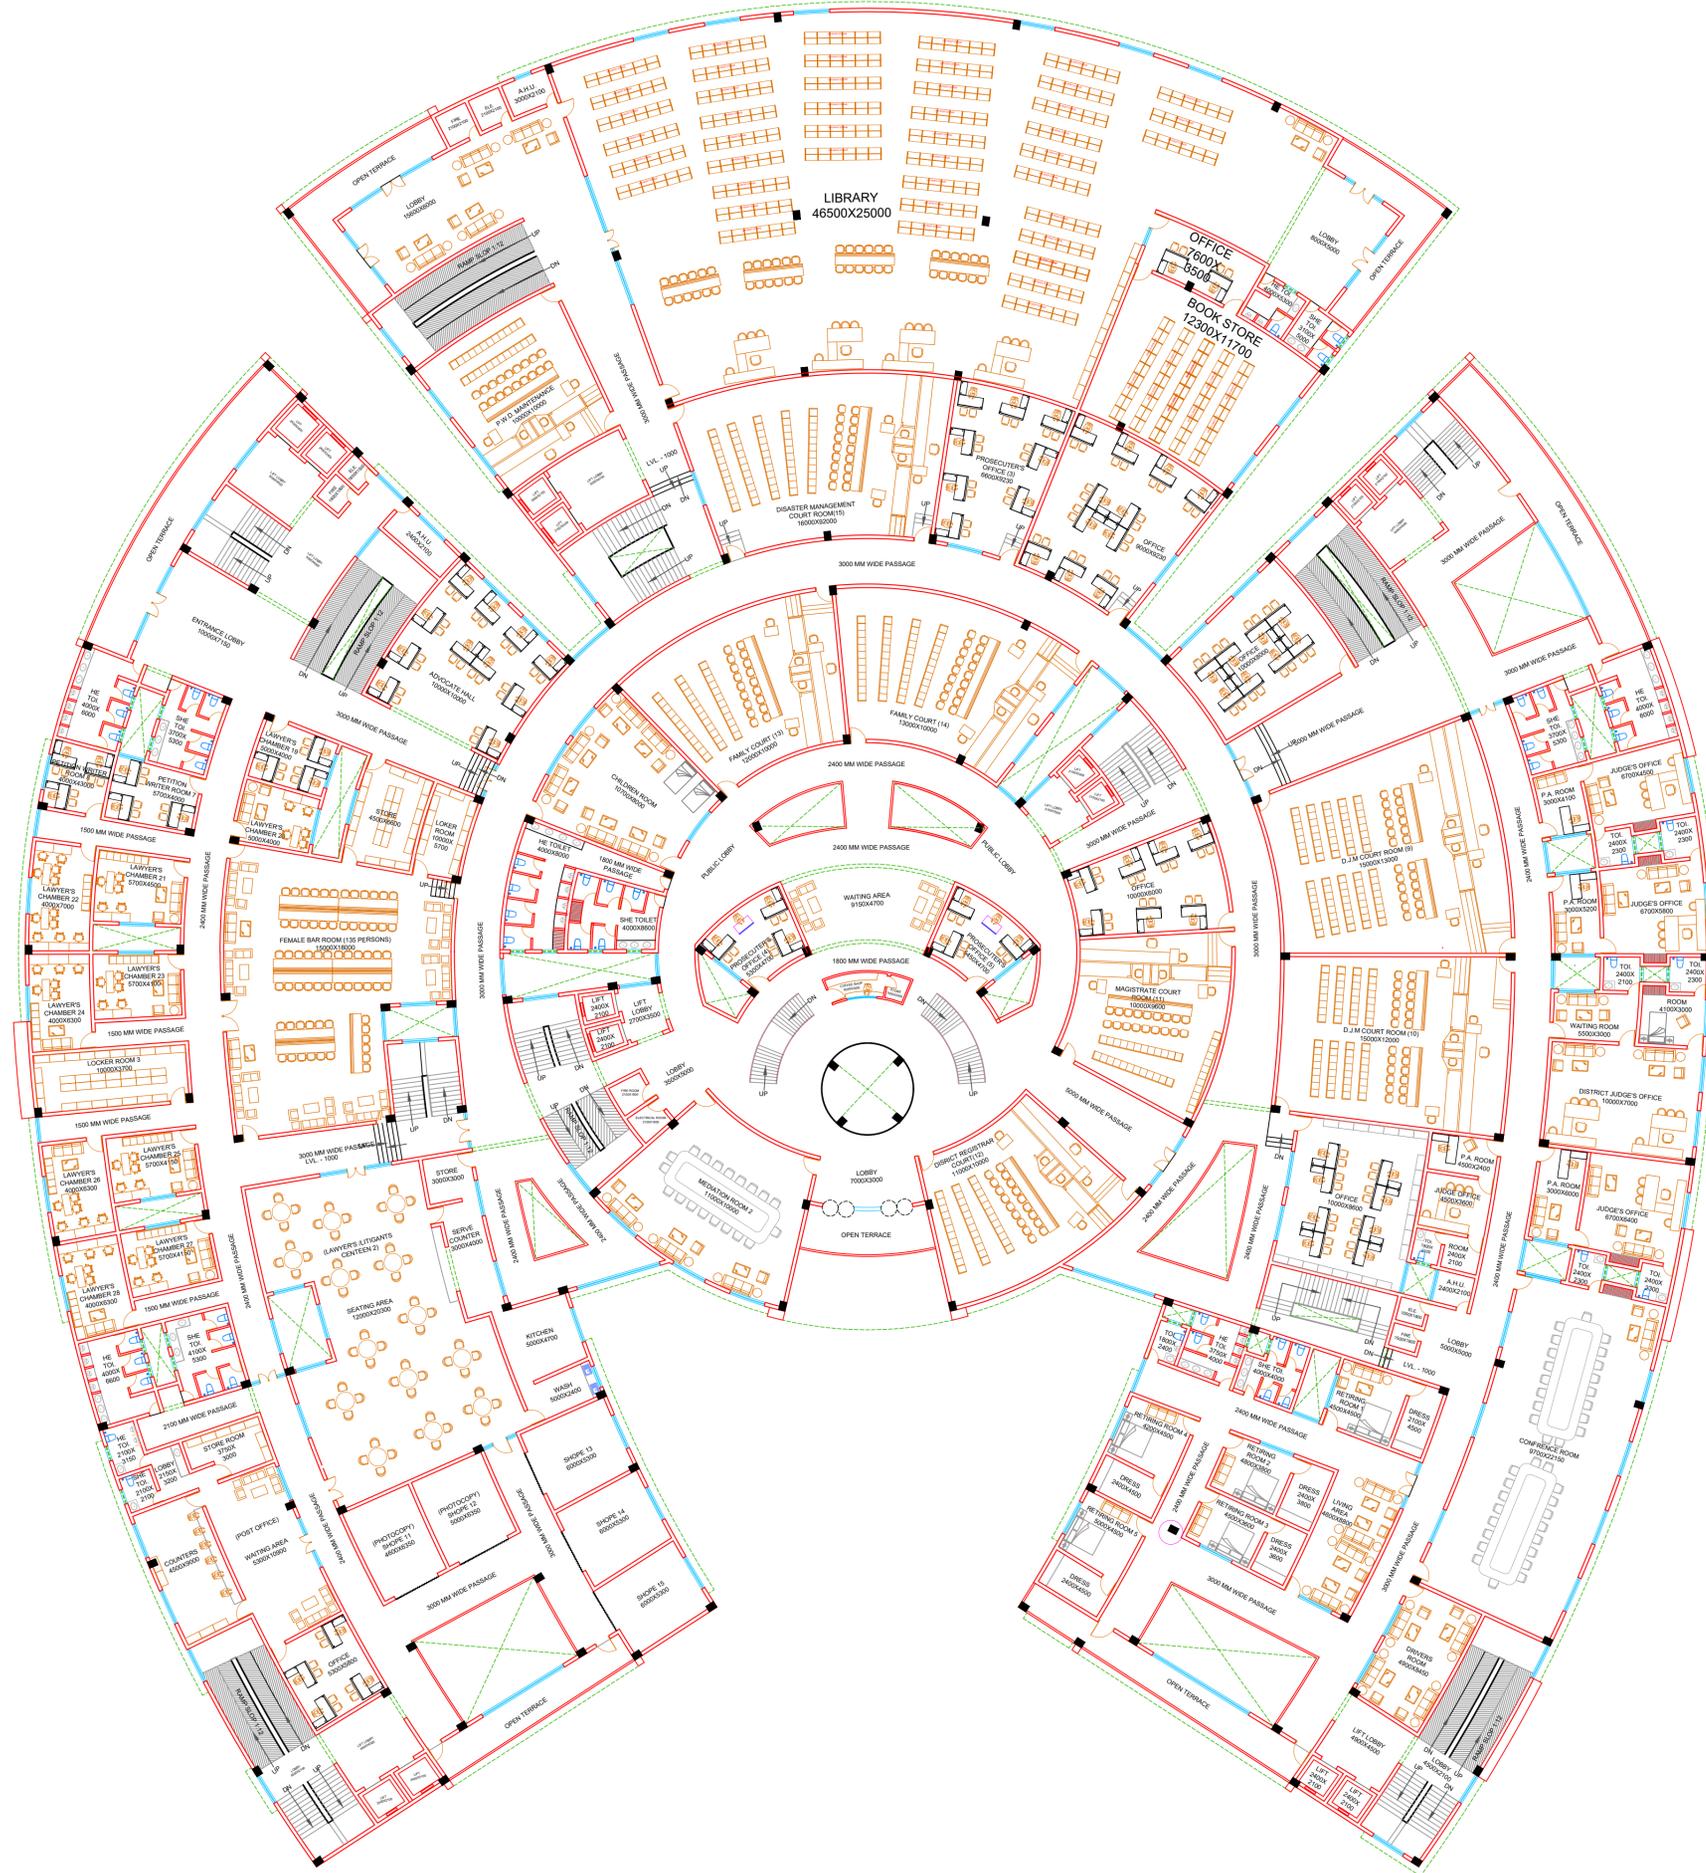

SECOND FLOOR PLAN



PROJECT TITLE

PROPOSED PLAN FOR  
'DISTRICT COURT COMPLEX  
AT DEHRADUN'



BYE LAWS :-  
SETBACKS  
FRONT = 15.00 M. | G. COVERAGE ALLOWED = 35%  
REAR = 6.00 M. | F.A.R. ALLOWED = 1.50  
SIDE - 1 = 6.00 M.  
SIDE - 2 = 6.00 M.

AREA STATEMENTS :-	
1. TOTAL PLOT AREA	= 26314.0 SQ. M. (= 6.30 ACRES)
2. PROPOSED COVERED AREA ON BASEMENT - 1 (SERVICES)	-- 9250.00 SQ.M.
3. PROPOSED COVERED AREA ON GROUND FLOOR	-- 7462.00 SQ.M.
4. PROPOSED COVERED AREA ON FIRST FLOOR	-- 7462.00 SQ.M.
5. PROPOSED COVERED AREA ON SECOND FLOOR	-- 7462.00 SQ.M.
6. PROPOSED COVERED AREA ON THIRD FLOOR	-- 7462.00 SQ.M.
7. PROP. COVD. AREA ON 4TH FL.	-- 7462.00 SQ.M.
8. PROP. COVD. AREA ON 5TH FL.	-- 53.00 SQ.M.
9. TOTAL COVERED AREA (IN F.A.R. - 12.50)	= 29901.00 SQ.M.
10. OPEN AREA ON GROUND FLOOR	-- 3063.00 SQ.M.
11. AREA OF PORCH	-- 290.62 SQ.M.
12. GROUND COVERAGE	-- 28.36 %
13. GREEN AREA	-- 17.3%
14. PROPOSED TOTAL PARKING	-- 345 ECS
15. AREA REQUIRED FOR @ 32 SQM. PER ECS.	-- 10880 SQM

NORTH


GENERAL NOTES  
All Dimensions are in mm. or specified

SCALE

STUDENT DETAIL  
Name - Poornima Raj Chaudhary  
Section - AR- 5-2  
Roll. No. - 1150101051

SHEET NO.

GUIDE DETAIL  
PR. MOHIT AGARWAL & AR. RAMAKANT

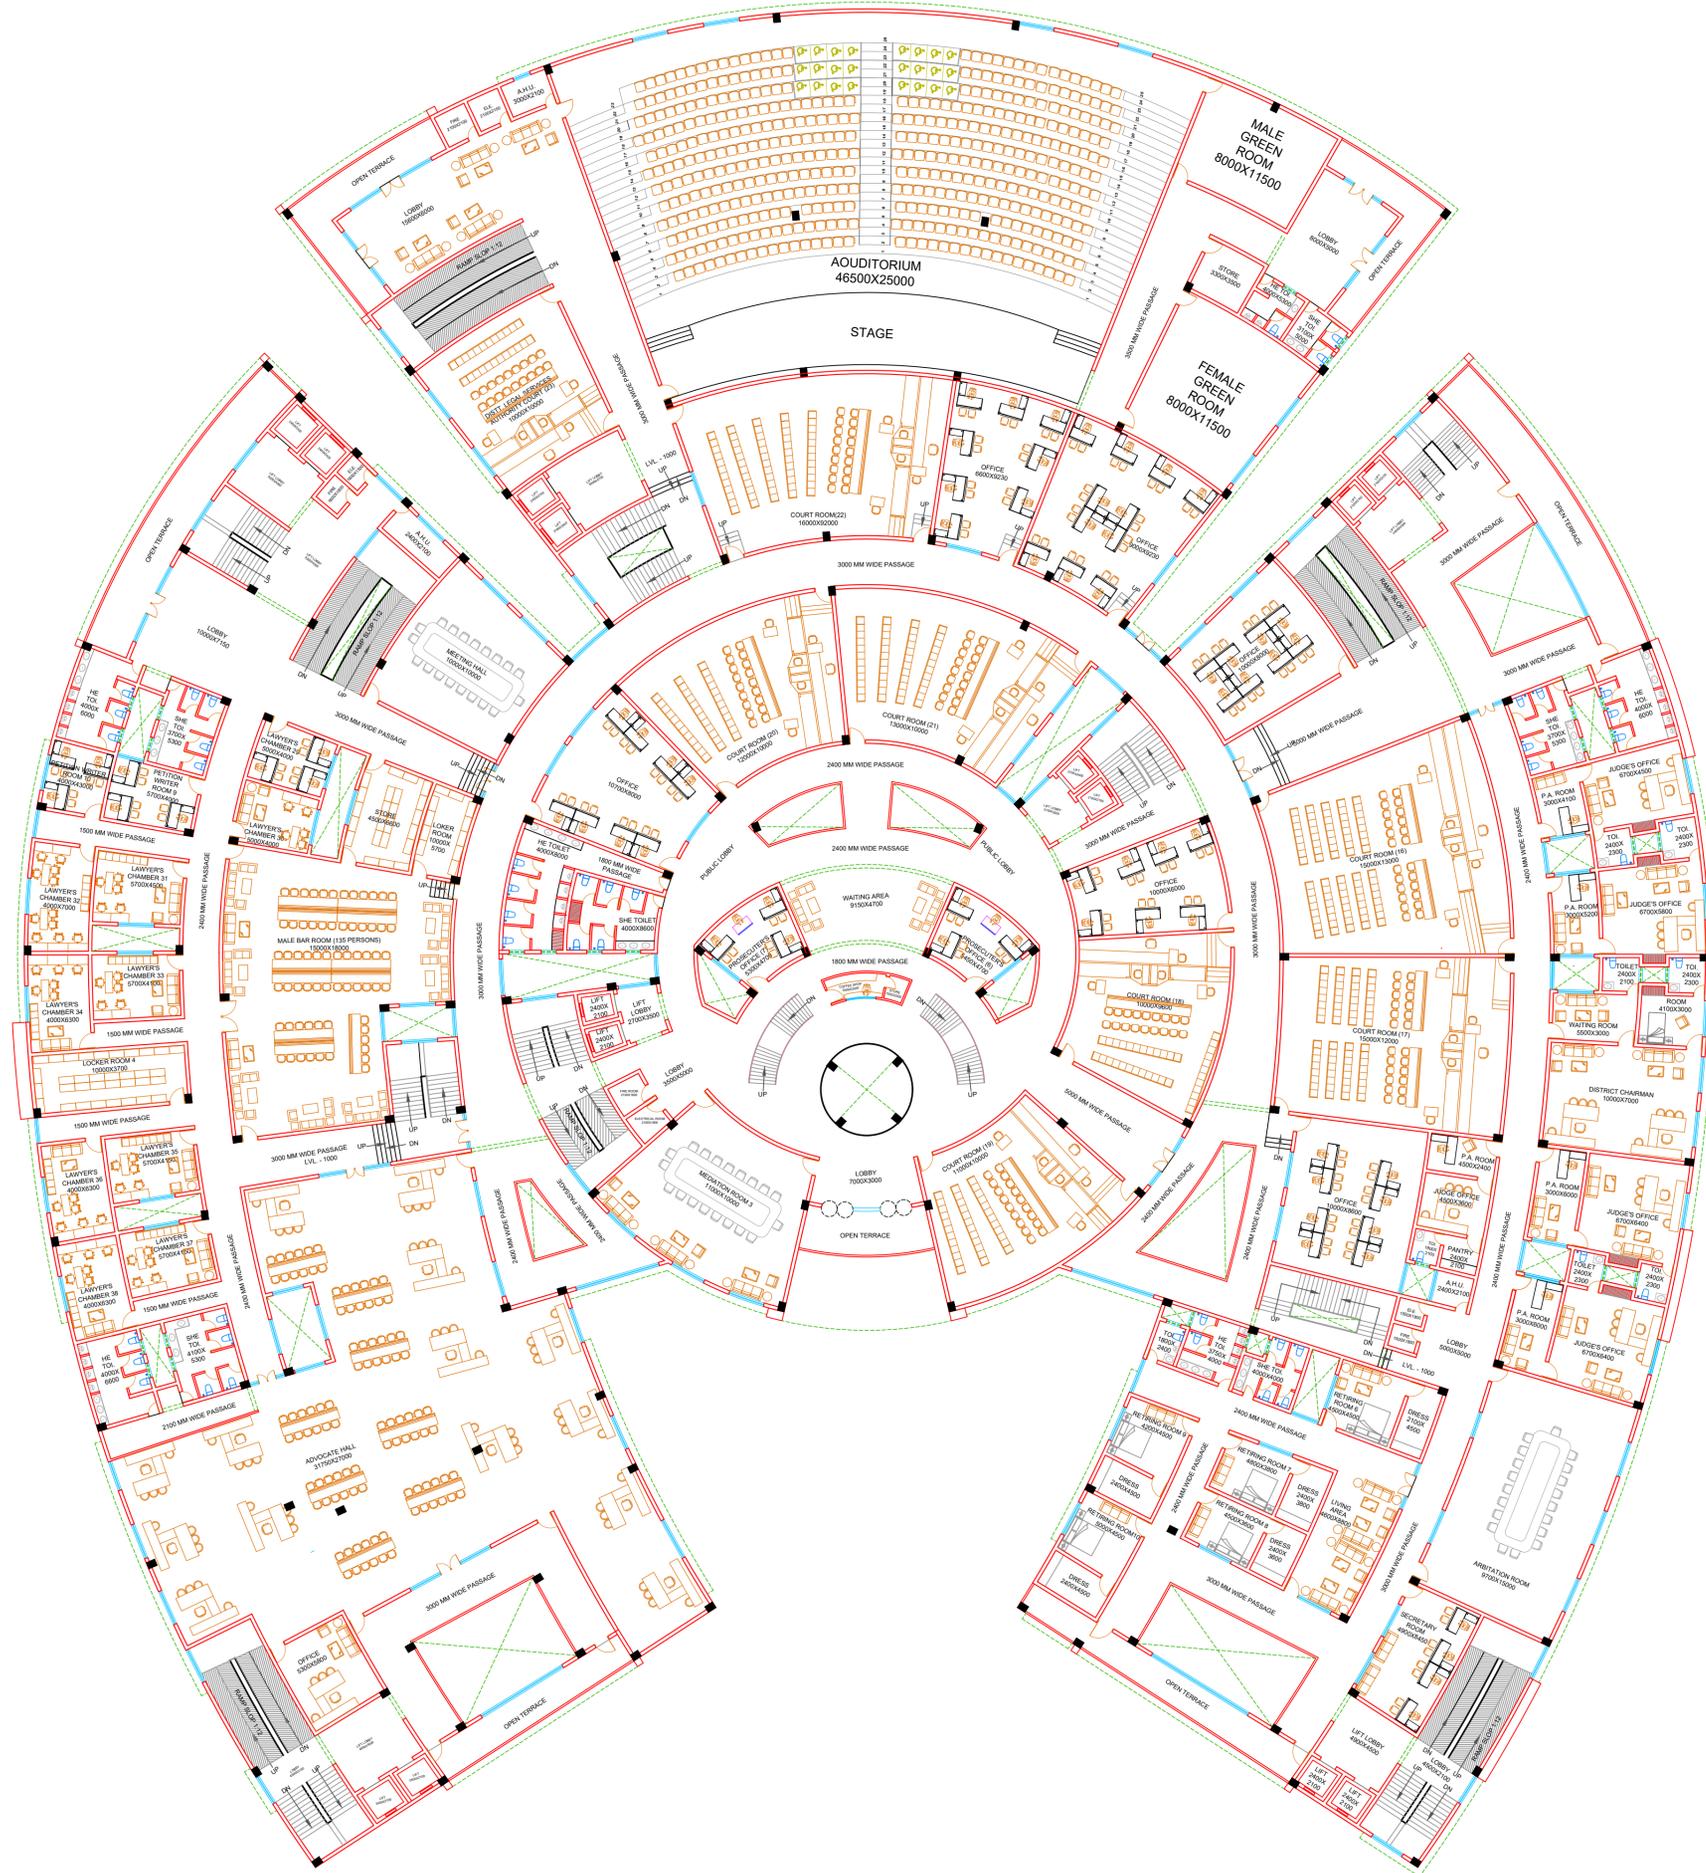

THIRD FLOOR PLAN



PROJECT TITLE

PROPOSED PLAN FOR  
'DISTRICT COURT COMPLEX  
AT DEHRADUN'



BYE LAWS :-  
SETBACKS  
FRONT = 15.00 M. | G. COVERAGE ALLOWED = 35%  
REAR = 6.00 M. | F.A.R. ALLOWED = 1.50  
SIDE - 1 = 6.00 M.  
SIDE - 2 = 6.00 M.

AREA STATEMENTS :-	
1. TOTAL PLOT AREA	= 26314.0 SQ. M. (= 6.30 ACRES)
2. PROPOSED COVERED AREA ON BASEMENT - 1 (SERVICES)	-- 9250.00 SQ.M.
3. PROPOSED COVERED AREA ON GROUND FLOOR	-- 7462.00 SQ.M.
4. PROPOSED COVERED AREA ON FIRST FLOOR	-- 7462.00 SQ.M.
5. PROPOSED COVERED AREA ON SECOND FLOOR	-- 7462.00 SQ.M.
6. PROPOSED COVERED AREA ON THIRD FLOOR	-- 7462.00 SQ.M.
7. PROP. COVD. AREA ON 4TH FL.	-- 7462.00 SQ.M.
8. PROP. COVD. AREA ON 5TH FL.	-- 53.00 SQ.M.
TOTAL COVERED AREA	
9. (IN F.A.R. - 12.50)	= 29901.00 SQ.M.
10. OPEN AREA ON GROUND FLOOR	-- 3063.00 SQ.M.
11. AREA OF PORCH	-- 290.62 SQ.M.
12. GROUND COVERAGE	-- 28.36 %
13. GREEN AREA	-- 17.3%
14. PROPOSED TOTAL PARKING	-- 345 ECS
15. AREA REQUIRED FOR @ 32 SQM. PER ECS.	-- 10880 SQM

NORTH


GENERAL NOTES  
All Dimensions are in mm. or specified

SCALE

STUDENT DETAIL  
Name - Poornima Raj Chaudhary  
Section - AR- 5-2  
Roll. No. - 1150101051

SHEET NO.

GUIDE DETAIL  
PR. MOHIT AGARWAL & AR. RAMAKANT

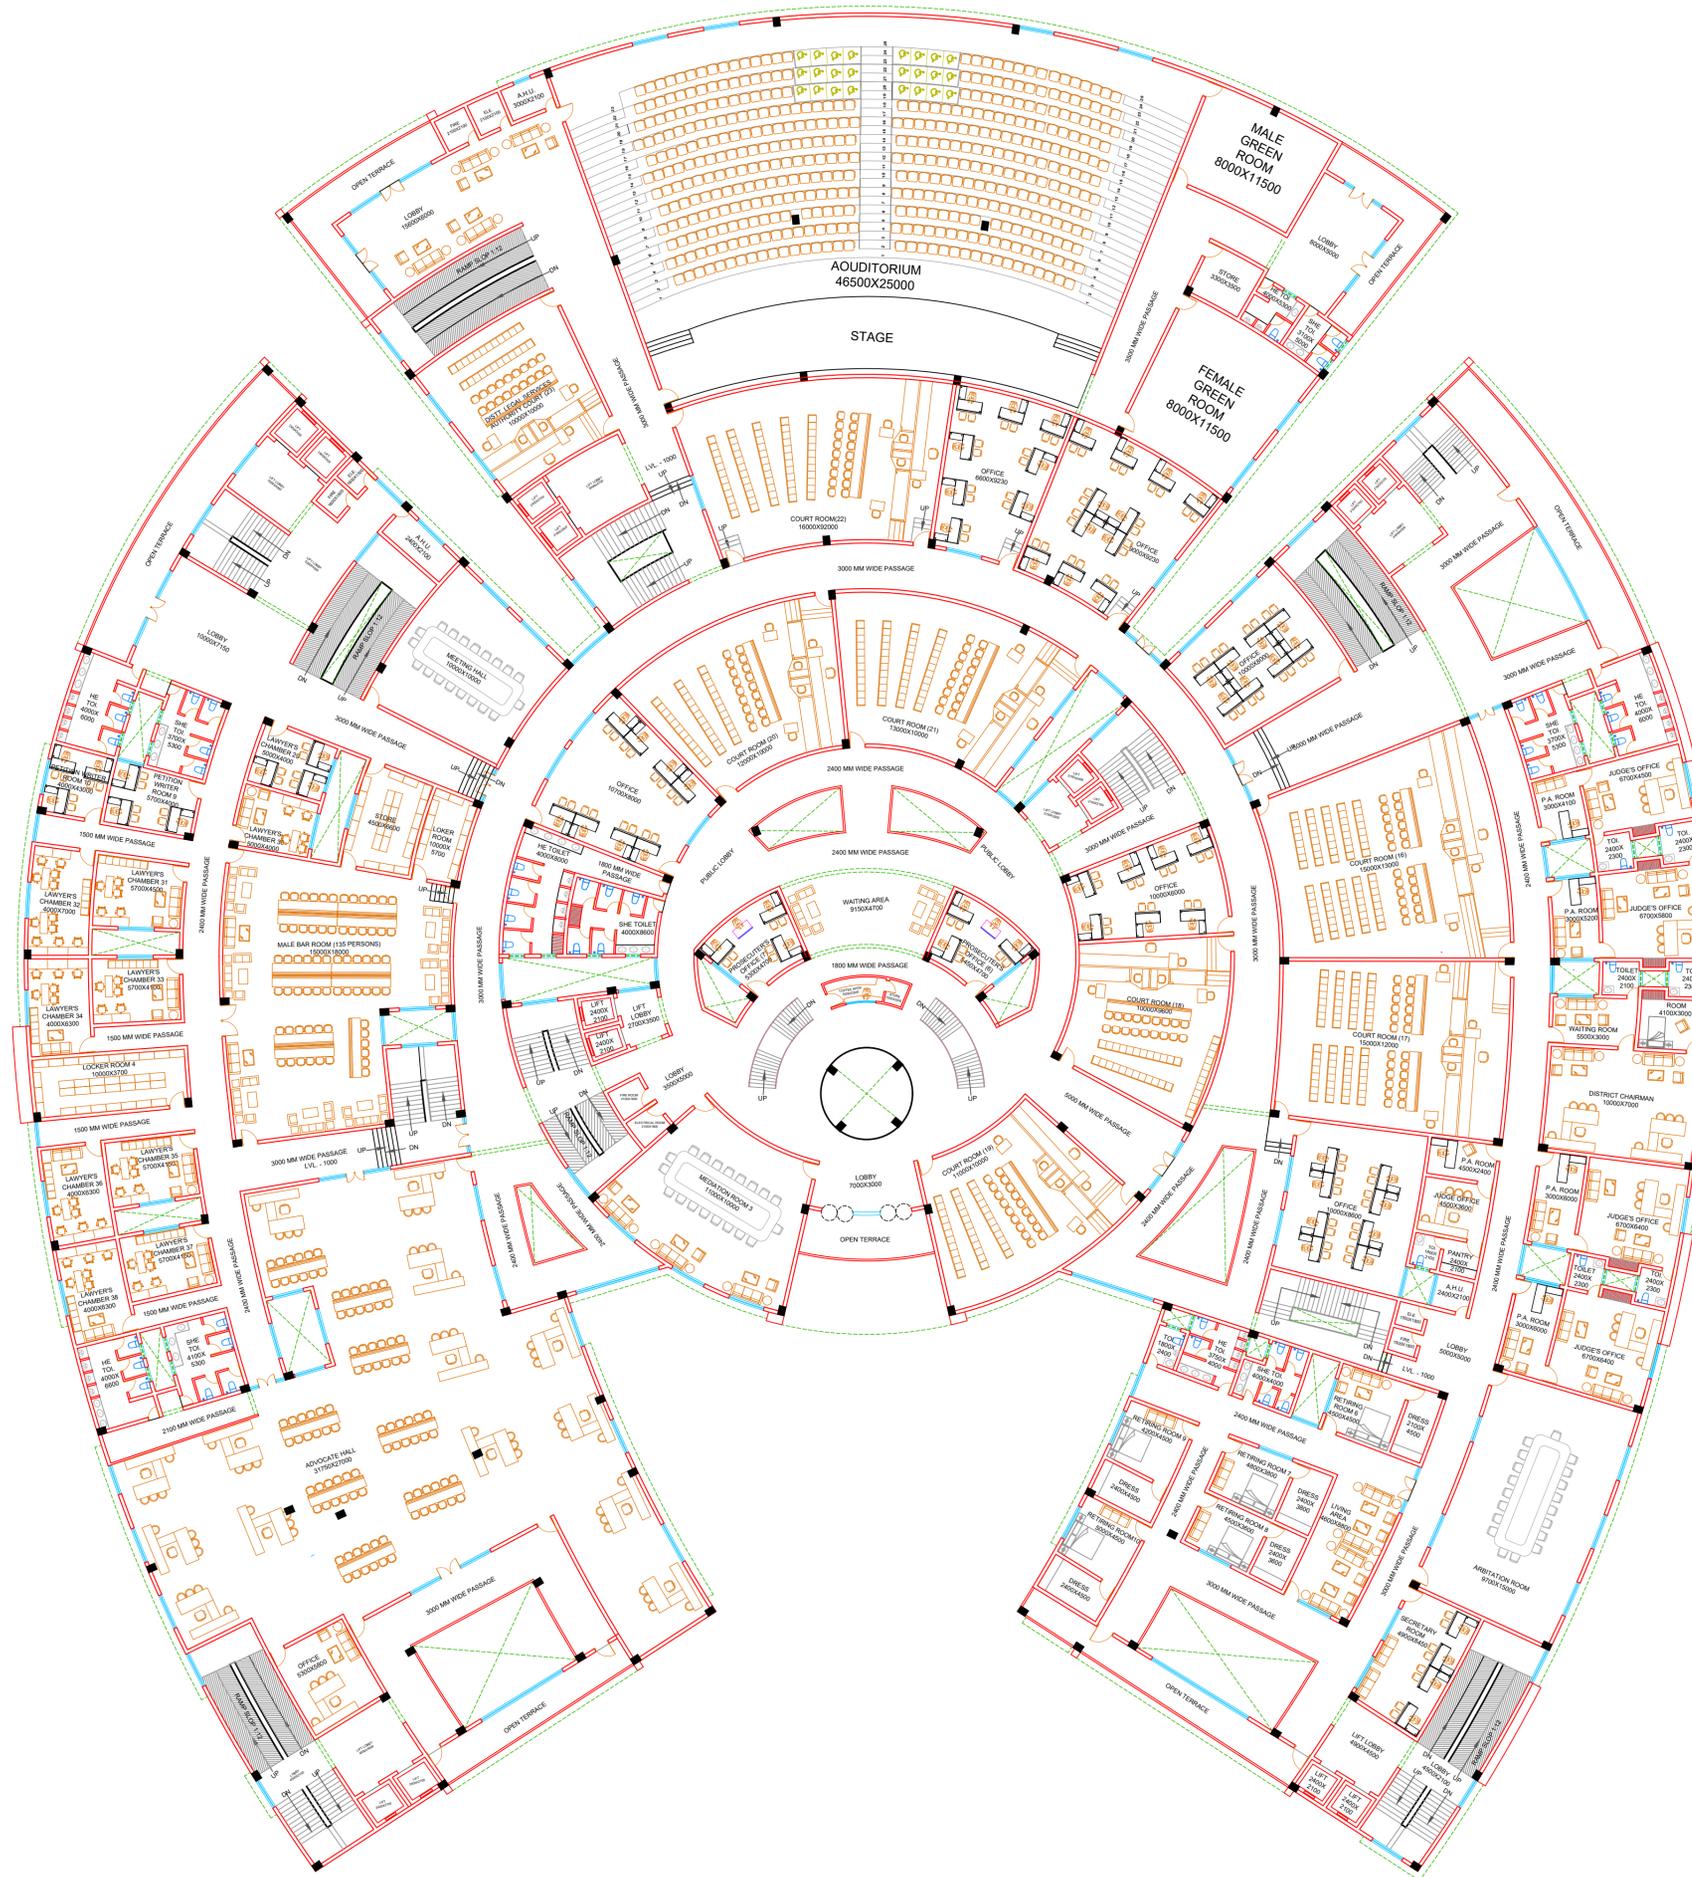

THIRD FLOOR PLAN



PROJECT TITLE

PROPOSED PLAN FOR  
'DISTRICT COURT COMPLEX  
AT DEHRADUN'



BYE LAWS :-  
SETBACKS  
FRONT = 15.00 M. | G. COVERAGE ALLOWED = 35%  
REAR = 6.00 M. | F.A.R. ALLOWED = 1.50  
SIDE - 1 = 6.00 M.  
SIDE - 2 = 6.00 M.

AREA STATEMENTS :-	
1. TOTAL PLOT AREA	= 26314.0 SQ. M. (= 6.30 ACRES)
2. PROPOSED COVERED AREA ON BASEMENT - 1 (SERVICES)	-- 9250.00 SQ.M.
3. PROPOSED COVERED AREA ON GROUND FLOOR	-- 7462.00 SQ.M.
4. PROPOSED COVERED AREA ON FIRST FLOOR	-- 7462.00 SQ.M.
5. PROPOSED COVERED AREA ON SECOND FLOOR	-- 7462.00 SQ.M.
6. PROPOSED COVERED AREA ON THIRD FLOOR	-- 7462.00 SQ.M.
7. PROP. COVD. AREA ON 4TH FL.	-- 7462.00 SQ.M.
8. PROP. COVD. AREA ON 5TH FL.	-- 53.00 SQ.M.
9. TOTAL COVERED AREA (IN F.A.R. - 12.50)	= 29901.00 SQ.M.
10. OPEN AREA ON GROUND FLOOR	-- 3063.00 SQ.M.
11. AREA OF PORCH	-- 290.62 SQ.M.
12. GROUND COVERAGE	-- 28.36 %
13. GREEN AREA	-- 17.3%
14. PROPOSED TOTAL PARKING	-- 345 ECS
15. AREA REQUIRED FOR @ 32 SQM. PER ECS.	-- 10880 SQM

NORTH


GENERAL NOTES  
All Dimensions are in mm. or specified

SCALE

STUDENT DETAIL  
Name - Poornima Raj Chaudhary  
Section - AR- 5-2  
Roll. No. - 1150101051

SHEET NO.

GUIDE DETAIL  
PR. MOHIT AGARWAL & AR. RAMAKANT

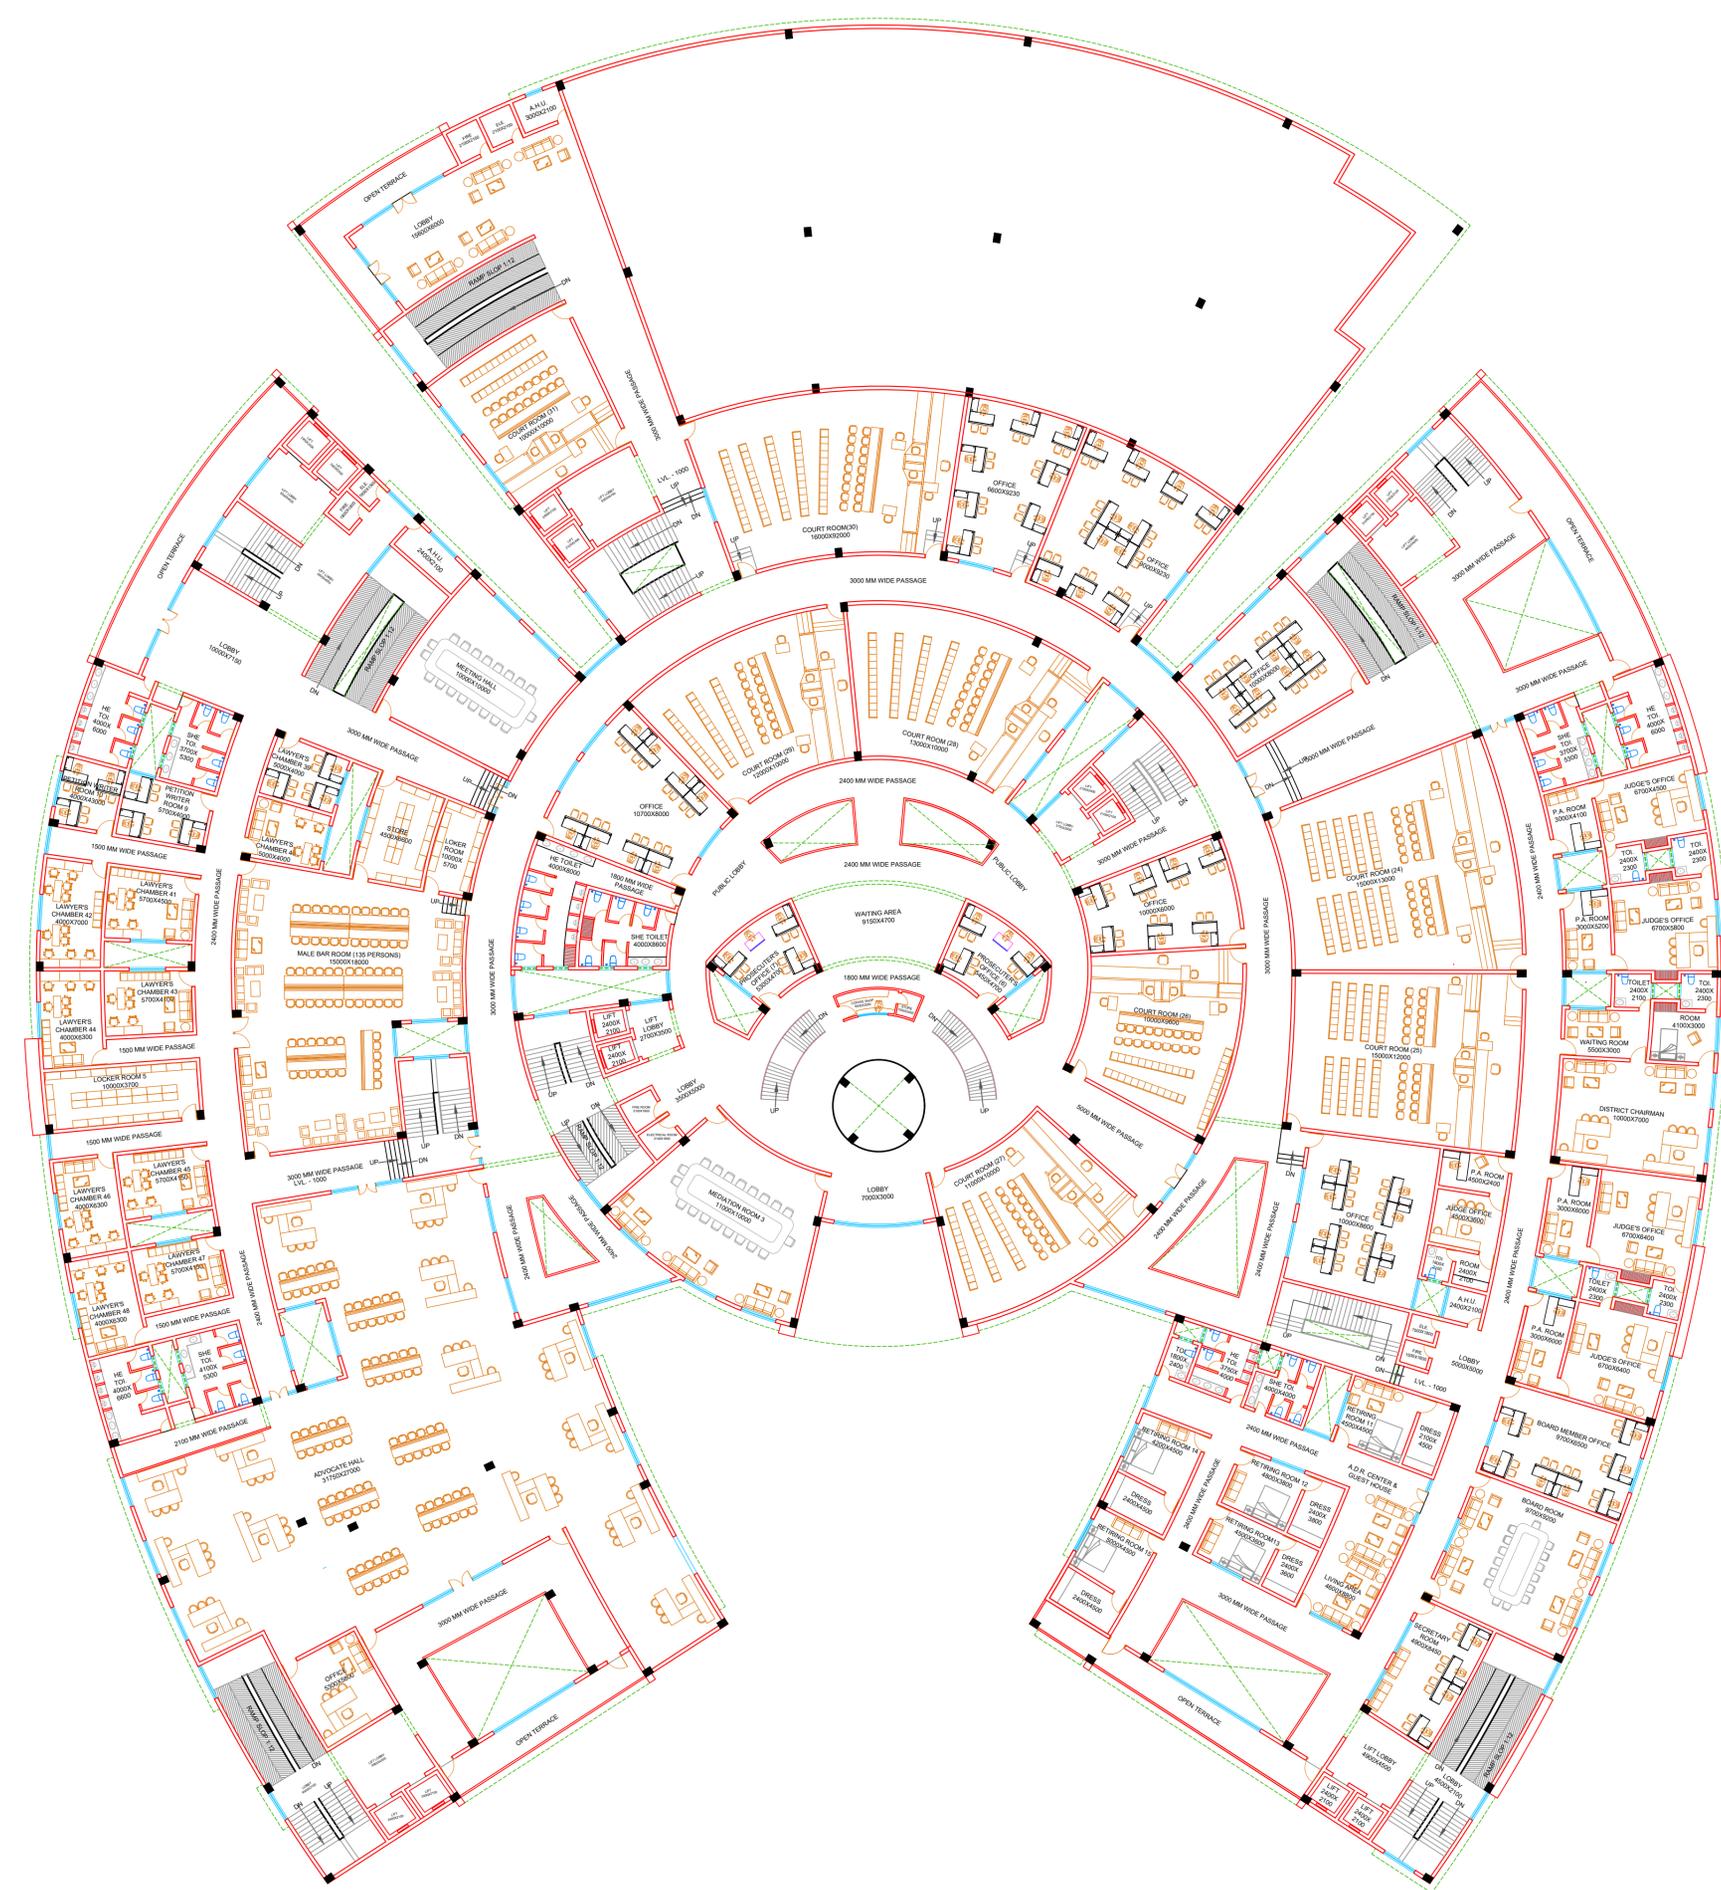

FOURTH FLOOR PLAN



PROJECT TITLE

PROPOSED PLAN FOR  
'DISTRICT COURT COMPLEX  
AT DEHRADUN'



BYE LAWS :-  
SETBACKS


FRONT = 15.00 M. G. COVERAGE ALLOWED = 35%  
REAR = 6.00 M. F.A.R. ALLOWED = 1.50  
SIDE - 1 = 6.00 M.  
SIDE - 2 = 6.00 M.

AREA STATEMENTS :-	
1. TOTAL PLOT AREA	= 26314.0 SQ. M. (= 6.30 ACRES)
2. PROPOSED COVERED AREA ON BASEMENT - 1 (SERVICES)	-- 9250.00 SQ.M.
3. PROPOSED COVERED AREA ON GROUND FLOOR	-- 7462.00 SQ.M.
4. PROPOSED COVERED AREA ON FIRST FLOOR	-- 7462.00 SQ.M.
5. PROPOSED COVERED AREA ON SECOND FLOOR	-- 7462.00 SQ.M.
6. PROPOSED COVERED AREA ON THIRD FLOOR	-- 7462.00 SQ.M.
7. PROP. COVD. AREA ON 4TH FL.	-- 7462.00 SQ.M.
8. PROP. COVD. AREA ON 5TH FL.	-- 53.00 SQ.M.
9. (IN F.A.R. - 12.50)	= 29901.00 SQ.M.
10. OPEN AREA ON GROUND FLOOR	-- 3063.00 SQ.M.
11. AREA OF PORCH	-- 290.62 SQ.M.
12. GROUND COVERAGE	-- 28.36 %
13. GREEN AREA	-- 17.3%
14. PROPOSED TOTAL PARKING	-- 345 ECS
15. AREA REQUIRED FOR @ 32 SQM. PER ECS.	-- 10880 SQM

<p>NORTH</p>	<p>GENERAL NOTES</p> <p>All Dimensions are in mm. or specified</p>
--------------	--

<p>SCALE</p>	<p>STUDENT DETAIL</p> <p>Name - Poornima Raj Chaudhary Section - AR- 5-2 Roll. No. - 1150101051</p>
--------------	---

<p>SHEET NO.</p>	<p>GUIDE DETAIL</p> <p>PR. MOHIT AGARWAL &amp; AR. RAMAKANT</p>
------------------	---

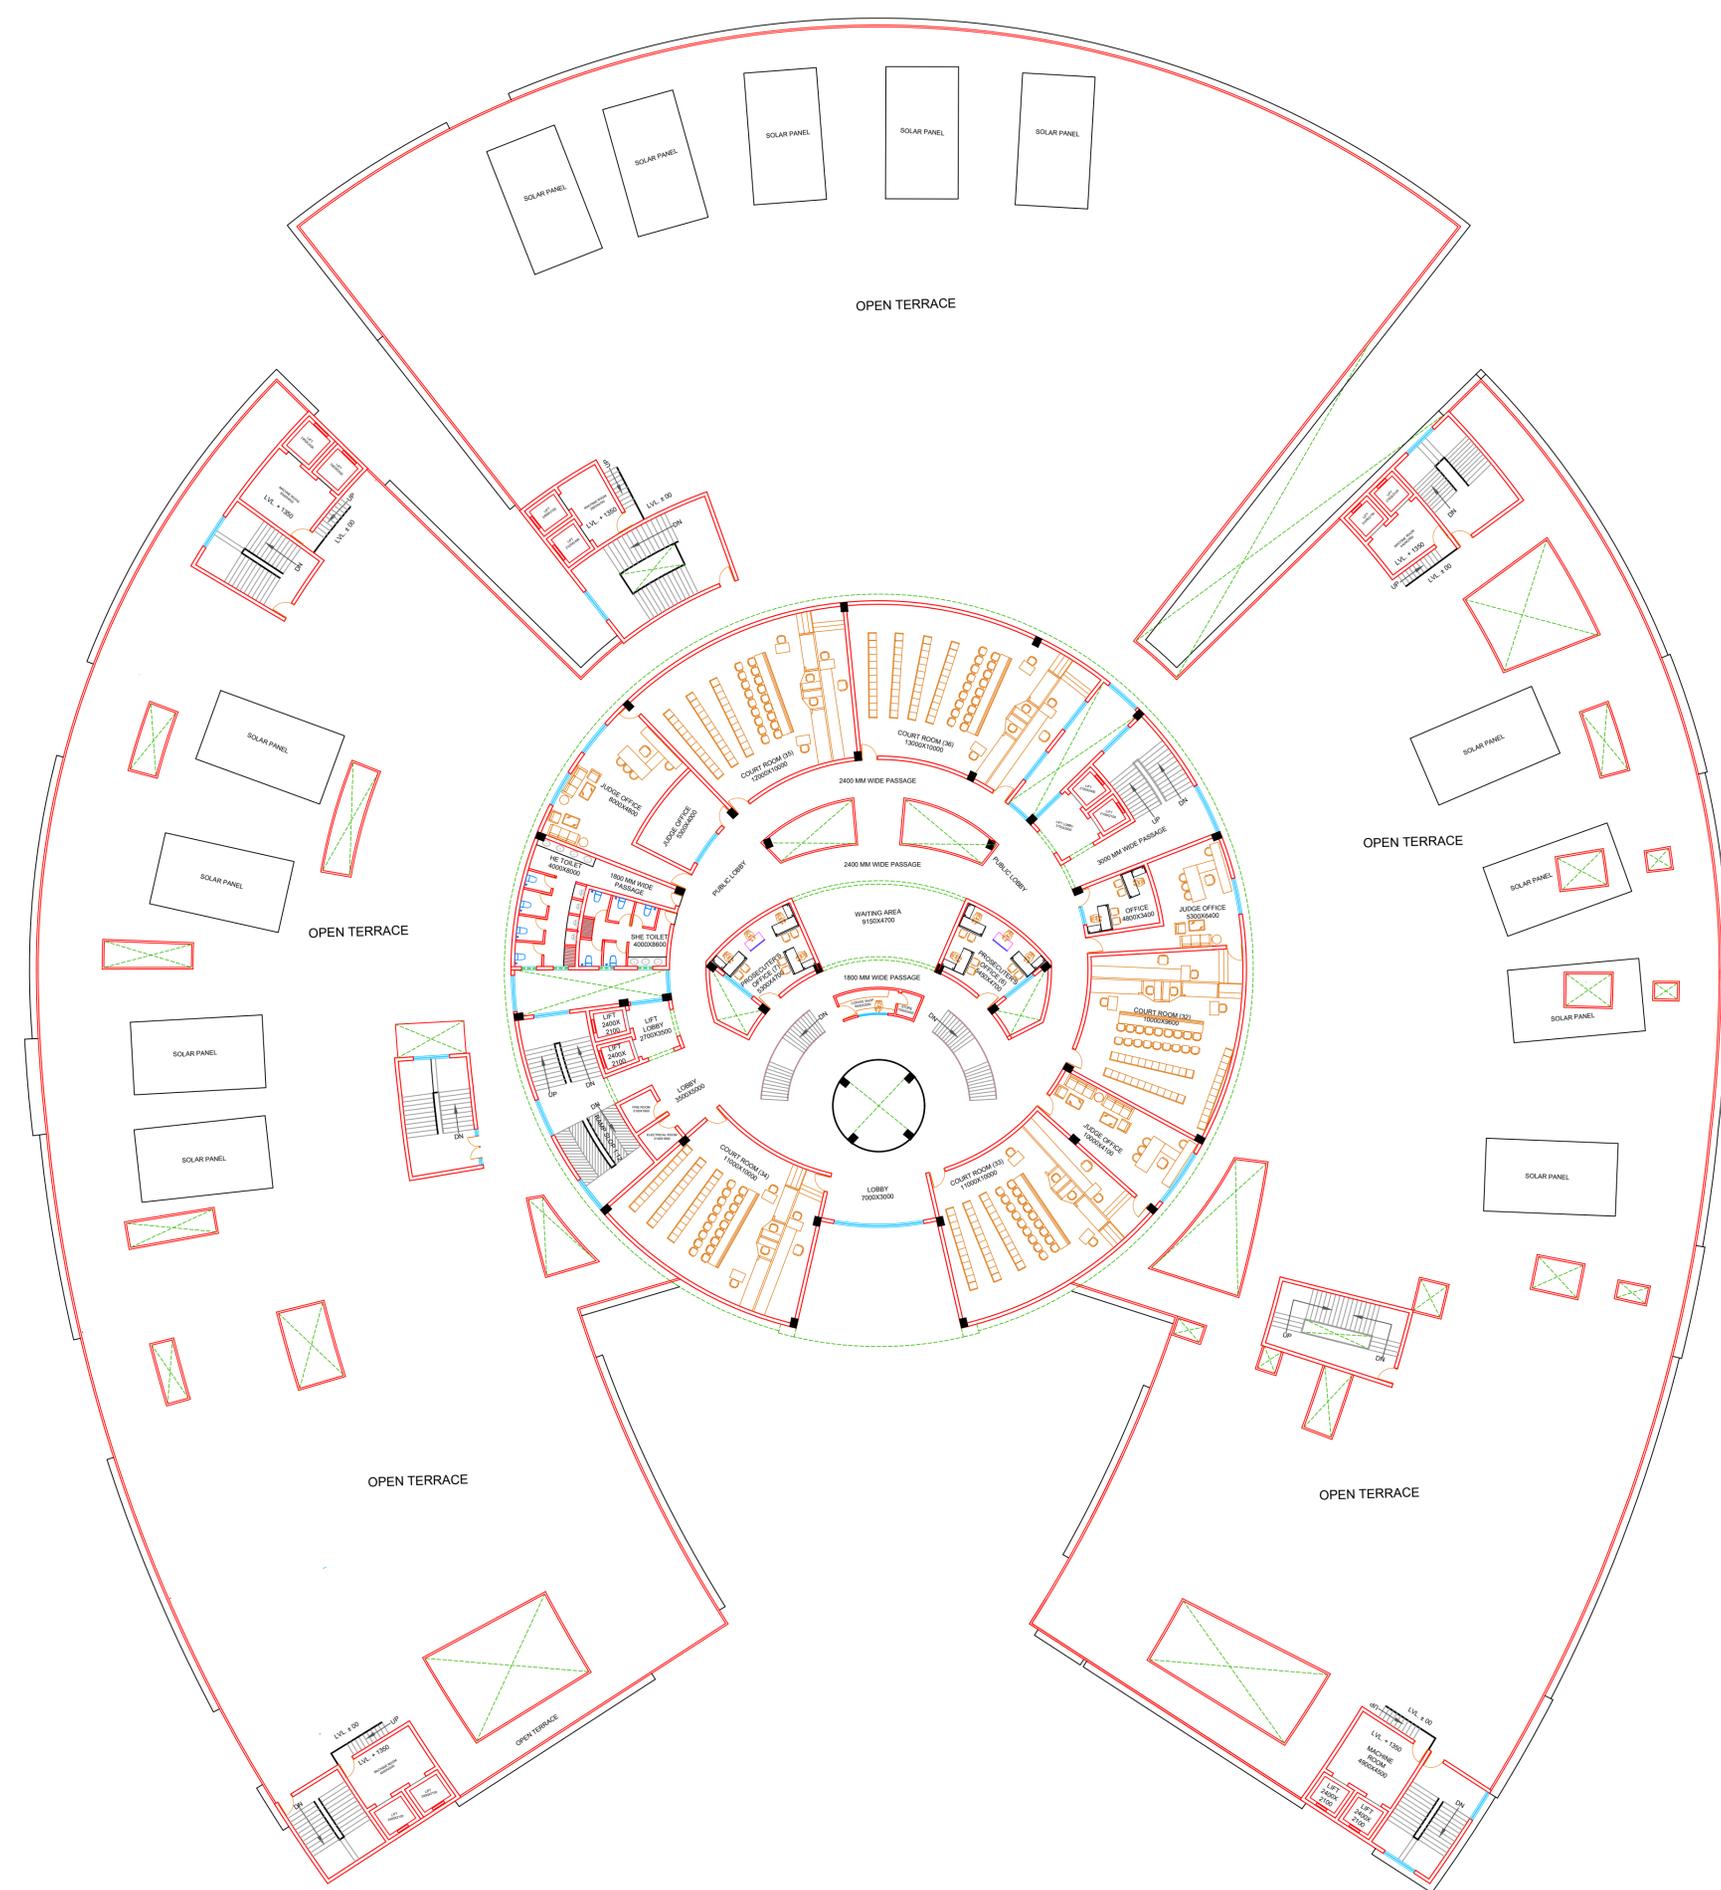

FIFTH FLOOR PLAN



**PROJECT TITLE**

**PROPOSED PLAN FOR  
'DISTRICT COURT COMPLEX  
AT DEHRADUN'**




**BYE LAWS :-  
SETBACKS**

FRONT = 15.00 M.	G. COVERAGE ALLOWED = 35%
REAR = 6.00 M.	F.A.R. ALLOWED = 1.50
SIDE - 1 = 6.00 M.	
SIDE - 2 = 6.00 M.	

**AREA STATEMENTS :-**

1. TOTAL PLOT AREA	= 26314.0 SQ. M. (= 6.30 ACRES)
2. PROPOSED COVERED AREA ON BASEMENT - 1 (SERVICES)	-- 9250.00 SQ.M.
3. PROPOSED COVERED AREA ON GROUND FLOOR	-- 7462.00 SQ.M.
4. PROPOSED COVERED AREA ON FIRST FLOOR	-- 7462.00 SQ.M.
5. PROPOSED COVERED AREA ON SECOND FLOOR	-- 7462.00 SQ.M.
6. PROPOSED COVERED AREA ON THIRD FLOOR	-- 7462.00 SQ.M.
7. PROP. COVD. AREA ON 4TH FL.	-- 7462.00 SQ.M.
8. PROP. COVD. AREA ON 5TH FL.	-- 53.00 SQ.M.
9. (IN F.A.R. - 12.50)	= 29901.00 SQ.M.
10. OPEN AREA ON GROUND FLOOR	-- 3063.00 SQ.M.
11. AREA OF PORCH	-- 290.62 SQ.M.
12. GROUND COVERAGE	-- 28.36 %
13. GREEN AREA	-- 17.3%
14. PROPOSED TOTAL PARKING	-- 345 ECS
15. AREA REQUIRED FOR @ 32 SQM. PER ECS.	-- 10880 SQM

**NORTH**

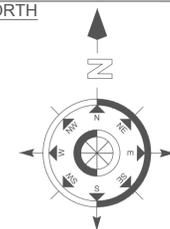

**GENERAL NOTES**

All Dimensions are in mm. or specified

**SCALE**


**STUDENT DETAIL**

Name - Poornima Raj Chaudhary  
Section - AR- 5-2  
Roll. No. - 1150101051

**SHEET NO.**

**GUIDE DETAIL**

PR. MOHIT AGARWAL & AR. RAMAKANT

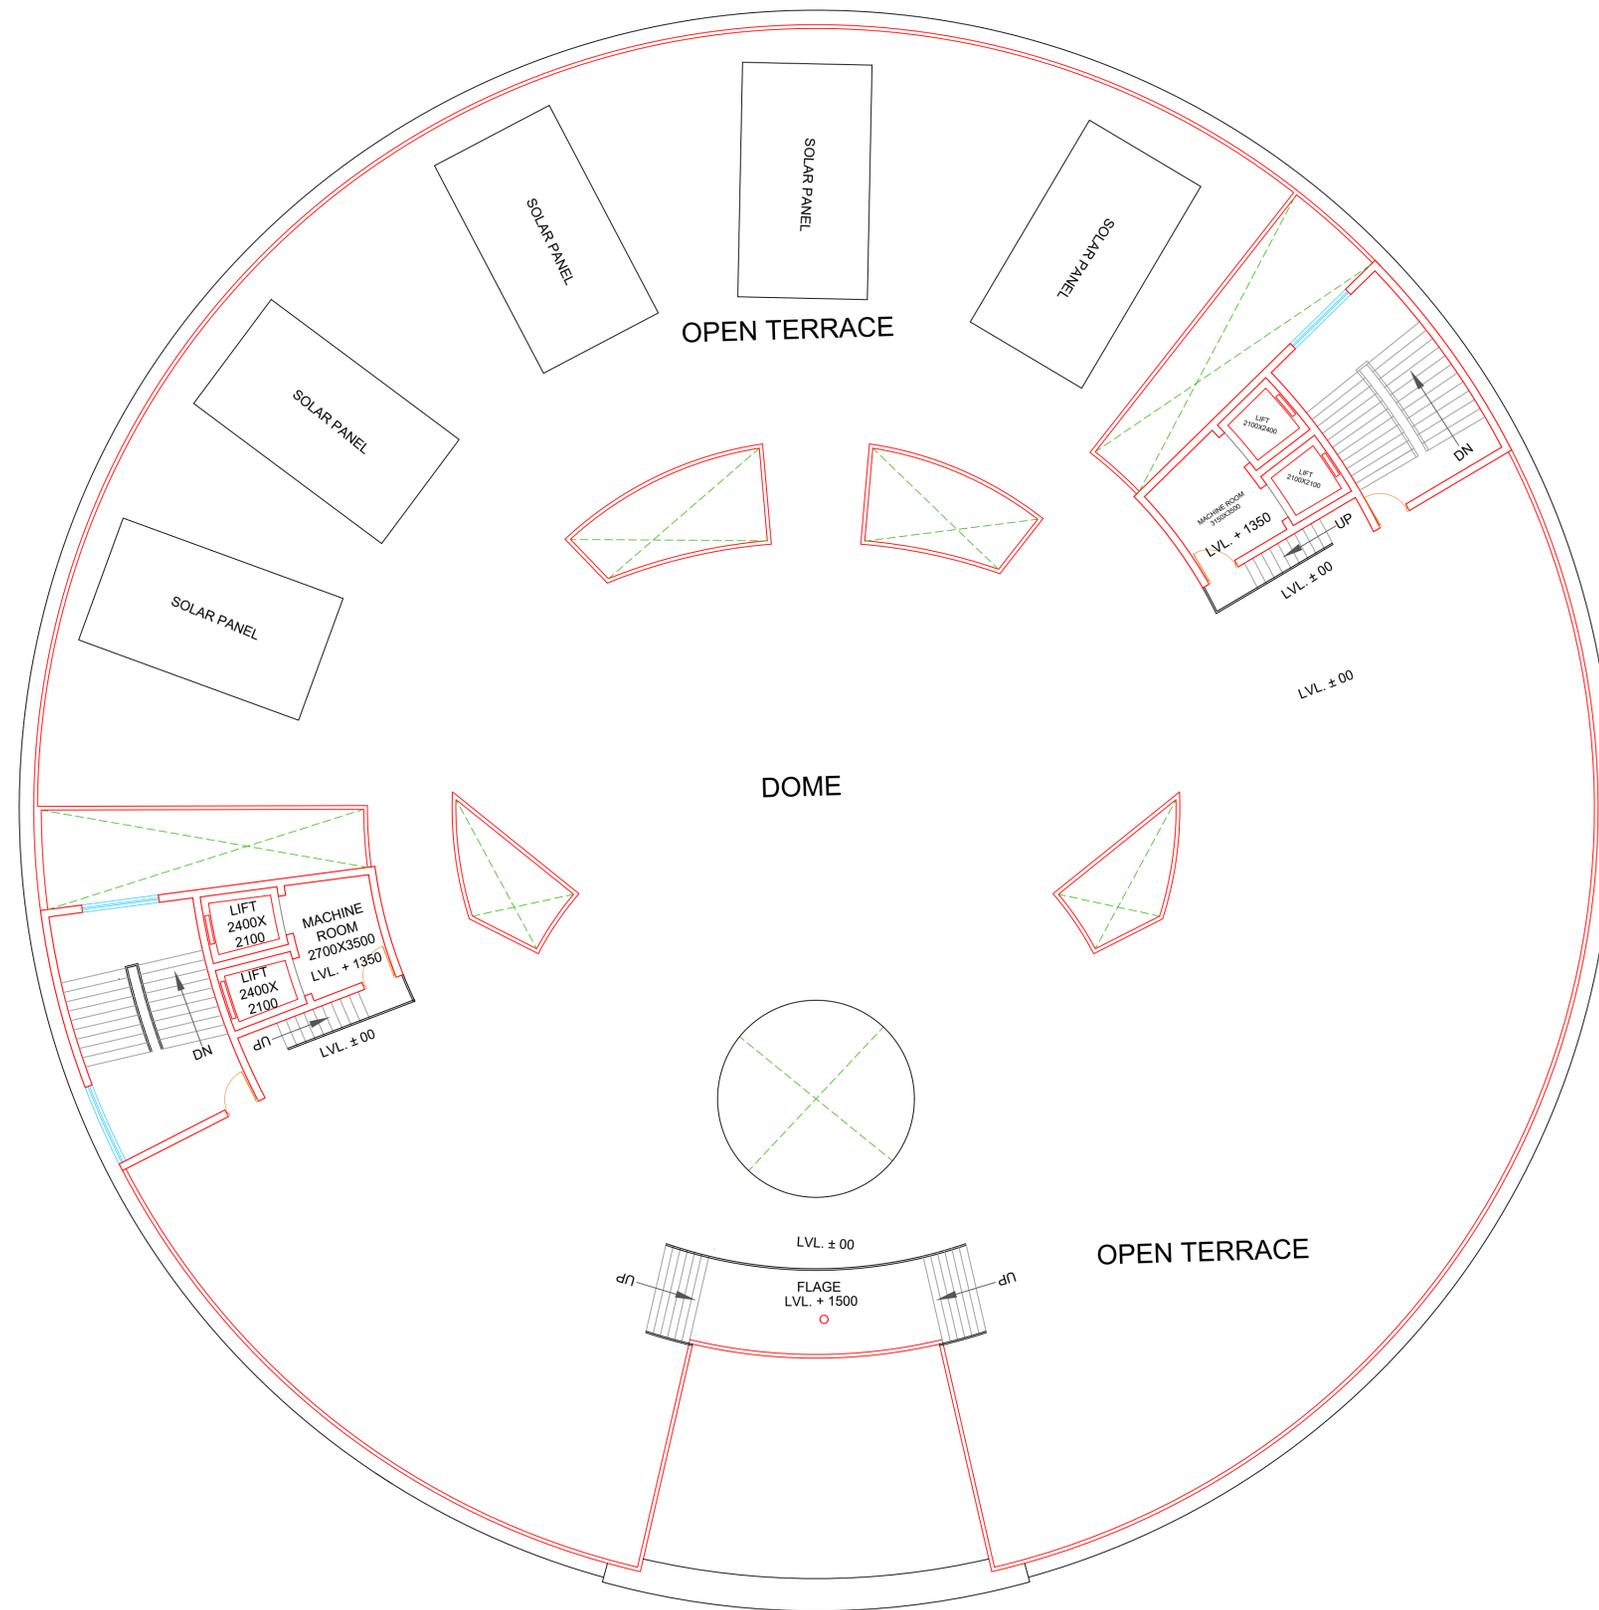

**TERRACE PLAN**





PROJECT TITLE

PROPOSED PLAN FOR  
'DISTRICT COURT COMPLEX  
AT DEHRADUN'




BYE LAWS :-  
SETBACKS

FRONT = 15.00 M. | G. COVERAGE ALLOWED = 35%  
REAR = 6.00 M. | F.A.R. ALLOWED = 1.50  
SIDE - 1 = 6.00 M.  
SIDE - 2 = 6.00 M.

AREA STATEMENTS :-

1.	TOTAL PLOT AREA	= 26314.0 SQ. M. (= 6.30 ACRES)
2.	PROPOSED COVERED AREA ON BASEMENT - 1 (SERVICES) (280 nos.ECS)--	8420.00 SQ.M.
3.	PROPOSED COVERED AREA ON GROUND FLOOR	-- 7462.00 SQ.M.
4.	PROPOSED COVERED AREA ON FIRST FLOOR	-- 7462.00 SQ.M.
5.	PROPOSED COVERED AREA ON SECOND FLOOR	-- 7462.00 SQ.M.
6.	PROPOSED COVERED AREA ON THIRD FLOOR	-- 7462.00 SQ.M.
7.	PROP. COVD. AREA ON 4TH FL.	-- 7462.00 SQ.M.
8.	TOTAL COVERED AREA (IN F.A.R. - 12.50)	= 29848.00 SQ.M.
9.	OPEN AREA ON GROUND FLOOR	-- 3063.00 SQ.M.
10.	AREA OF PORCH	-- 290.62 SQ.M.
11.	GROUND COVERAGE	-- 28.36 %
12.	GREEN AREA	-- 17.3%
13.	PROPOSED TOTAL PARKING	-- 345 ECS
14.	AREA REQUIRED FOR @ 32 SQM. PER ECS.--	10880 SQM
15.		

NORTH

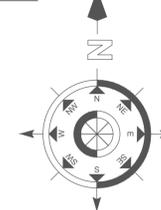

SCALE


GENERAL NOTES

All Dimensions are in mm. or specified


SHEET NO.

GUIDE DETAIL

PR. MOHIT AGARWAL  
&  
AR. RAMAKANT

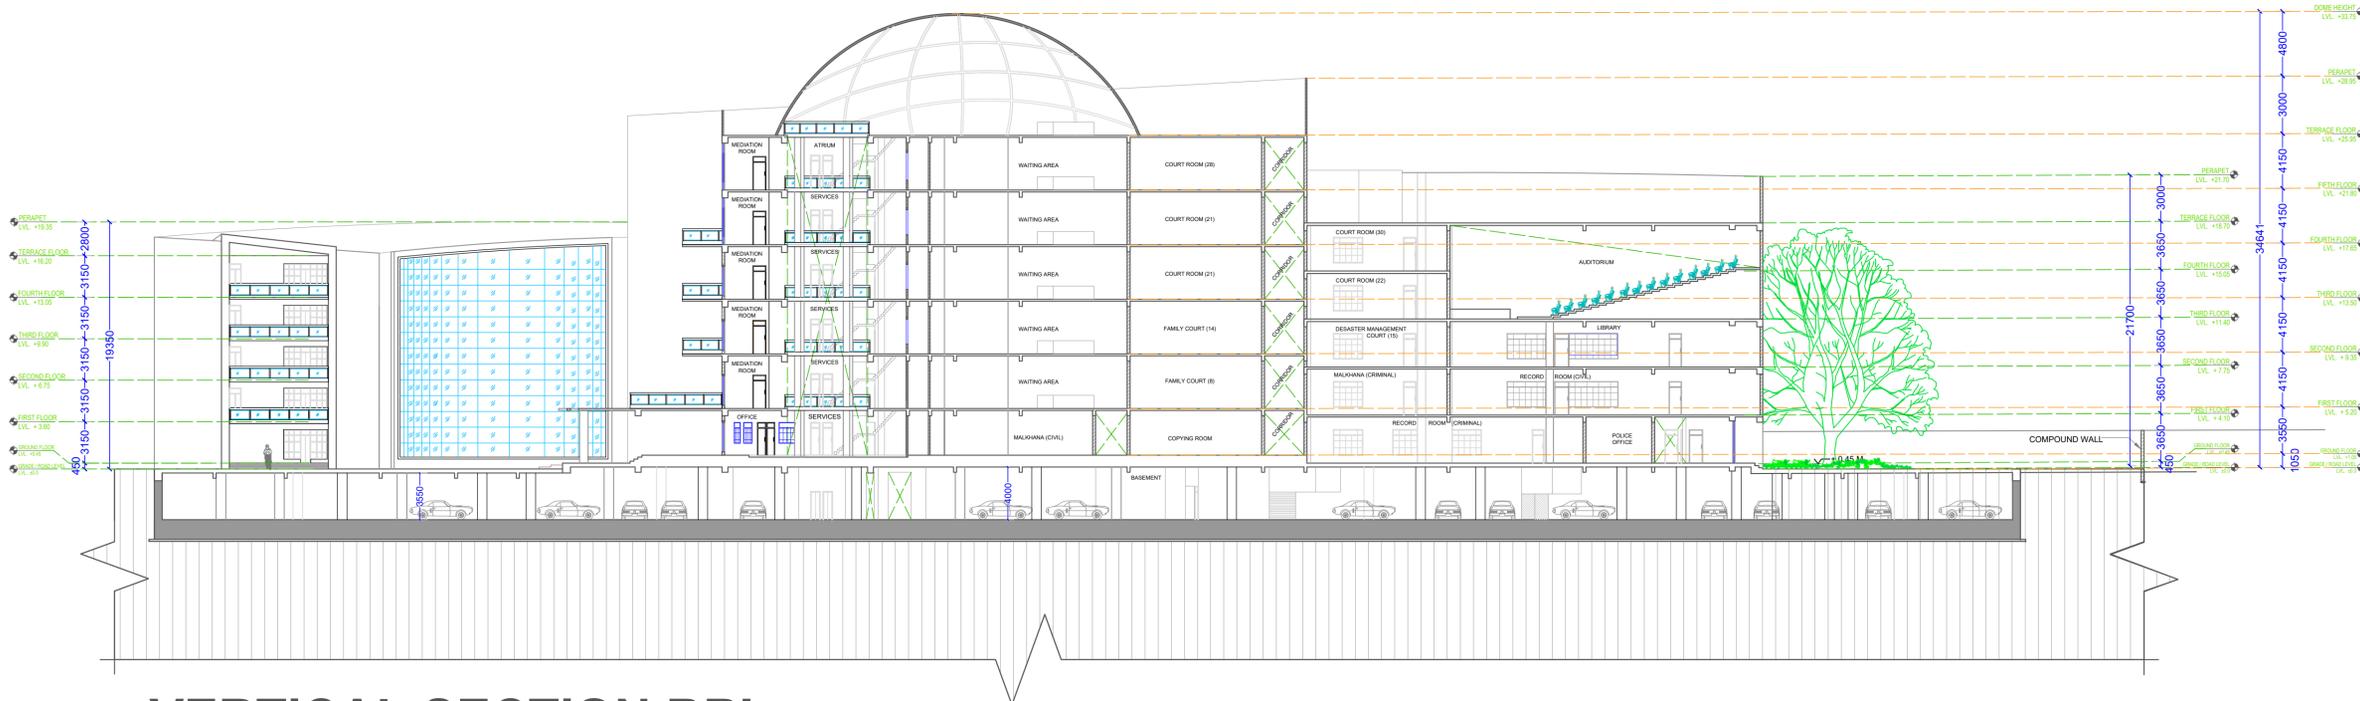

**VERTICAL SECTION BB'**  
(THROUGH ENTRANCE LOBBY)

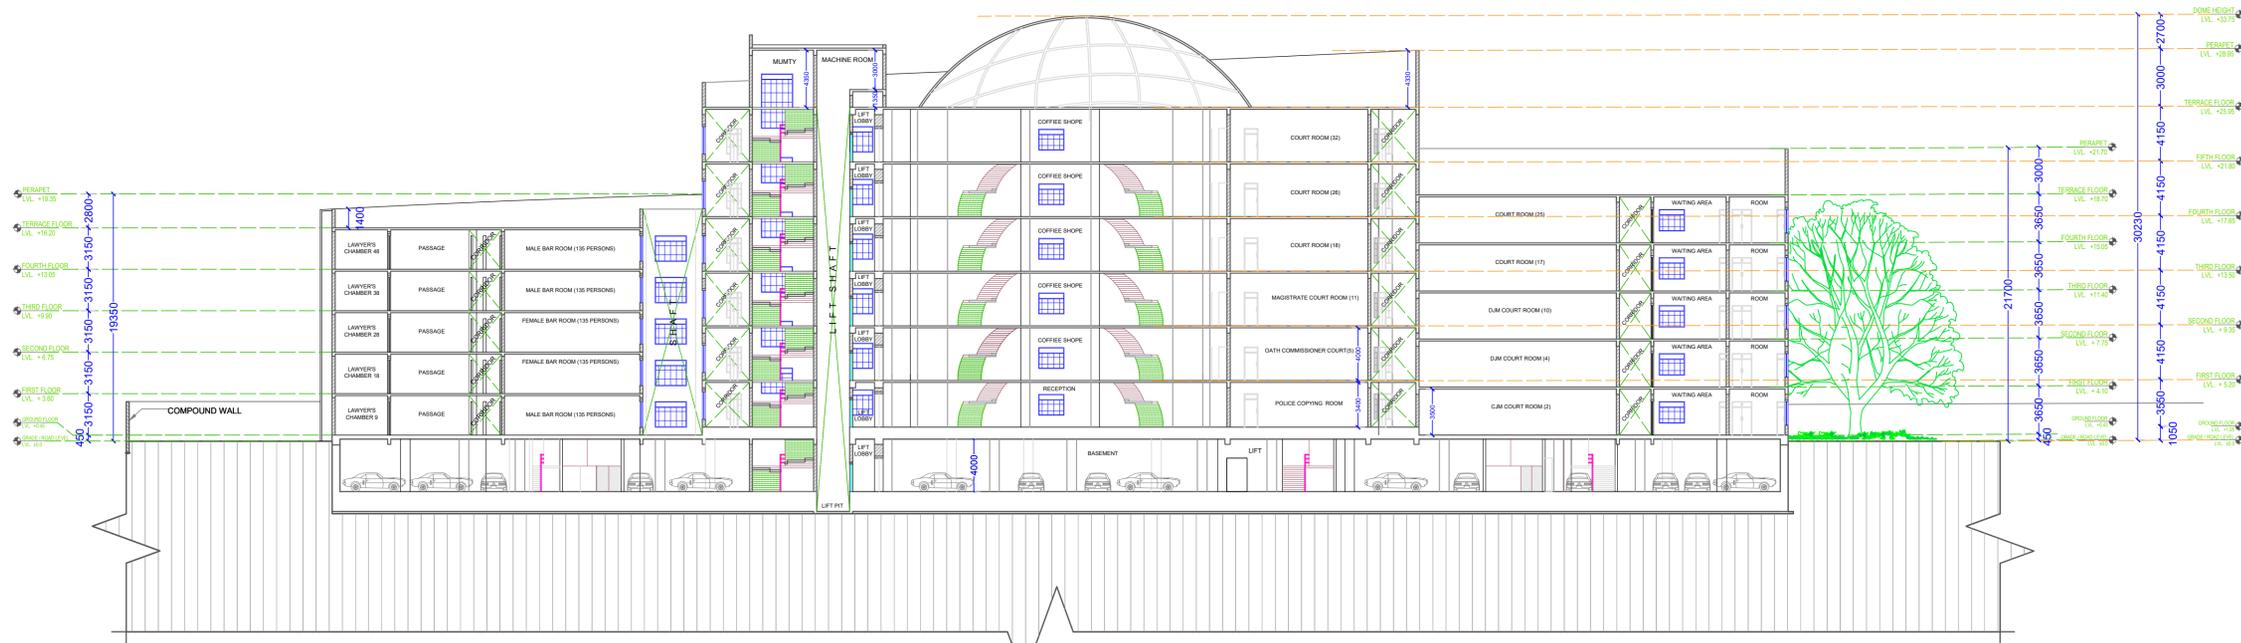

**HORIZONTAL SECTION AA'**  
(THROUGH ENTRANCE LOBBY)





PROJECT TITLE

PROPOSED PLAN FOR  
'DISTRICT COURT COMPLEX  
AT DEHRADUN'



BYE LAWS :-  
SETBACKS  
FRONT = 15.00 M. G. COVERAGE ALLOWED = 35%  
REAR = 6.00 M. F.A.R. ALLOWED = 1.50  
SIDE - 1 = 6.00 M.  
SIDE - 2 = 6.00 M.

AREA STATEMENTS :-	
1. TOTAL PLOT AREA	= 26314.0 SQ. M. (= 6.30 ACRES)
2. PROPOSED COVERED AREA ON BASEMENT - 1 (SERVICES)	-- 9250.00 SQ.M.
3. PROPOSED COVERED AREA ON GROUND FLOOR	-- 7462.00 SQ.M.
4. PROPOSED COVERED AREA ON FIRST FLOOR	-- 7462.00 SQ.M.
5. PROPOSED COVERED AREA ON SECOND FLOOR	-- 7462.00 SQ.M.
6. PROPOSED COVERED AREA ON THIRD FLOOR	-- 7462.00 SQ.M.
7. PROP. COVD. AREA ON 4TH FL.	-- 7462.00 SQ.M.
8. PROP. COVD. AREA ON 5TH FL.	-- 53.00 SQ.M.
9. TOTAL COVERED AREA (IN F.A.R. - 12.50)	= 29901.00 SQ.M.
10. OPEN AREA ON GROUND FLOOR	-- 3063.00 SQ.M.
11. AREA OF PORCH	-- 290.62 SQ.M.
12. GROUND COVERAGE	-- 28.36 %
13. GREEN AREA	-- 17.3%
14. PROPOSED TOTAL PARKING	-- 345 ECS
15. AREA REQUIRED FOR @ 32 SQM. PER ECS.	-- 10880 SQM

NORTH

GENERAL NOTES

All Dimensions are in mm. or specified

SCALE


STUDENT DETAIL

Name - Poornima Raj Chaudhary  
Section - AR- 5-2  
Roll. No. - 1150101051

SHEET NO.

GUIDE DETAIL

PR. MOHIT AGARWAL & AR. RAMAKANT

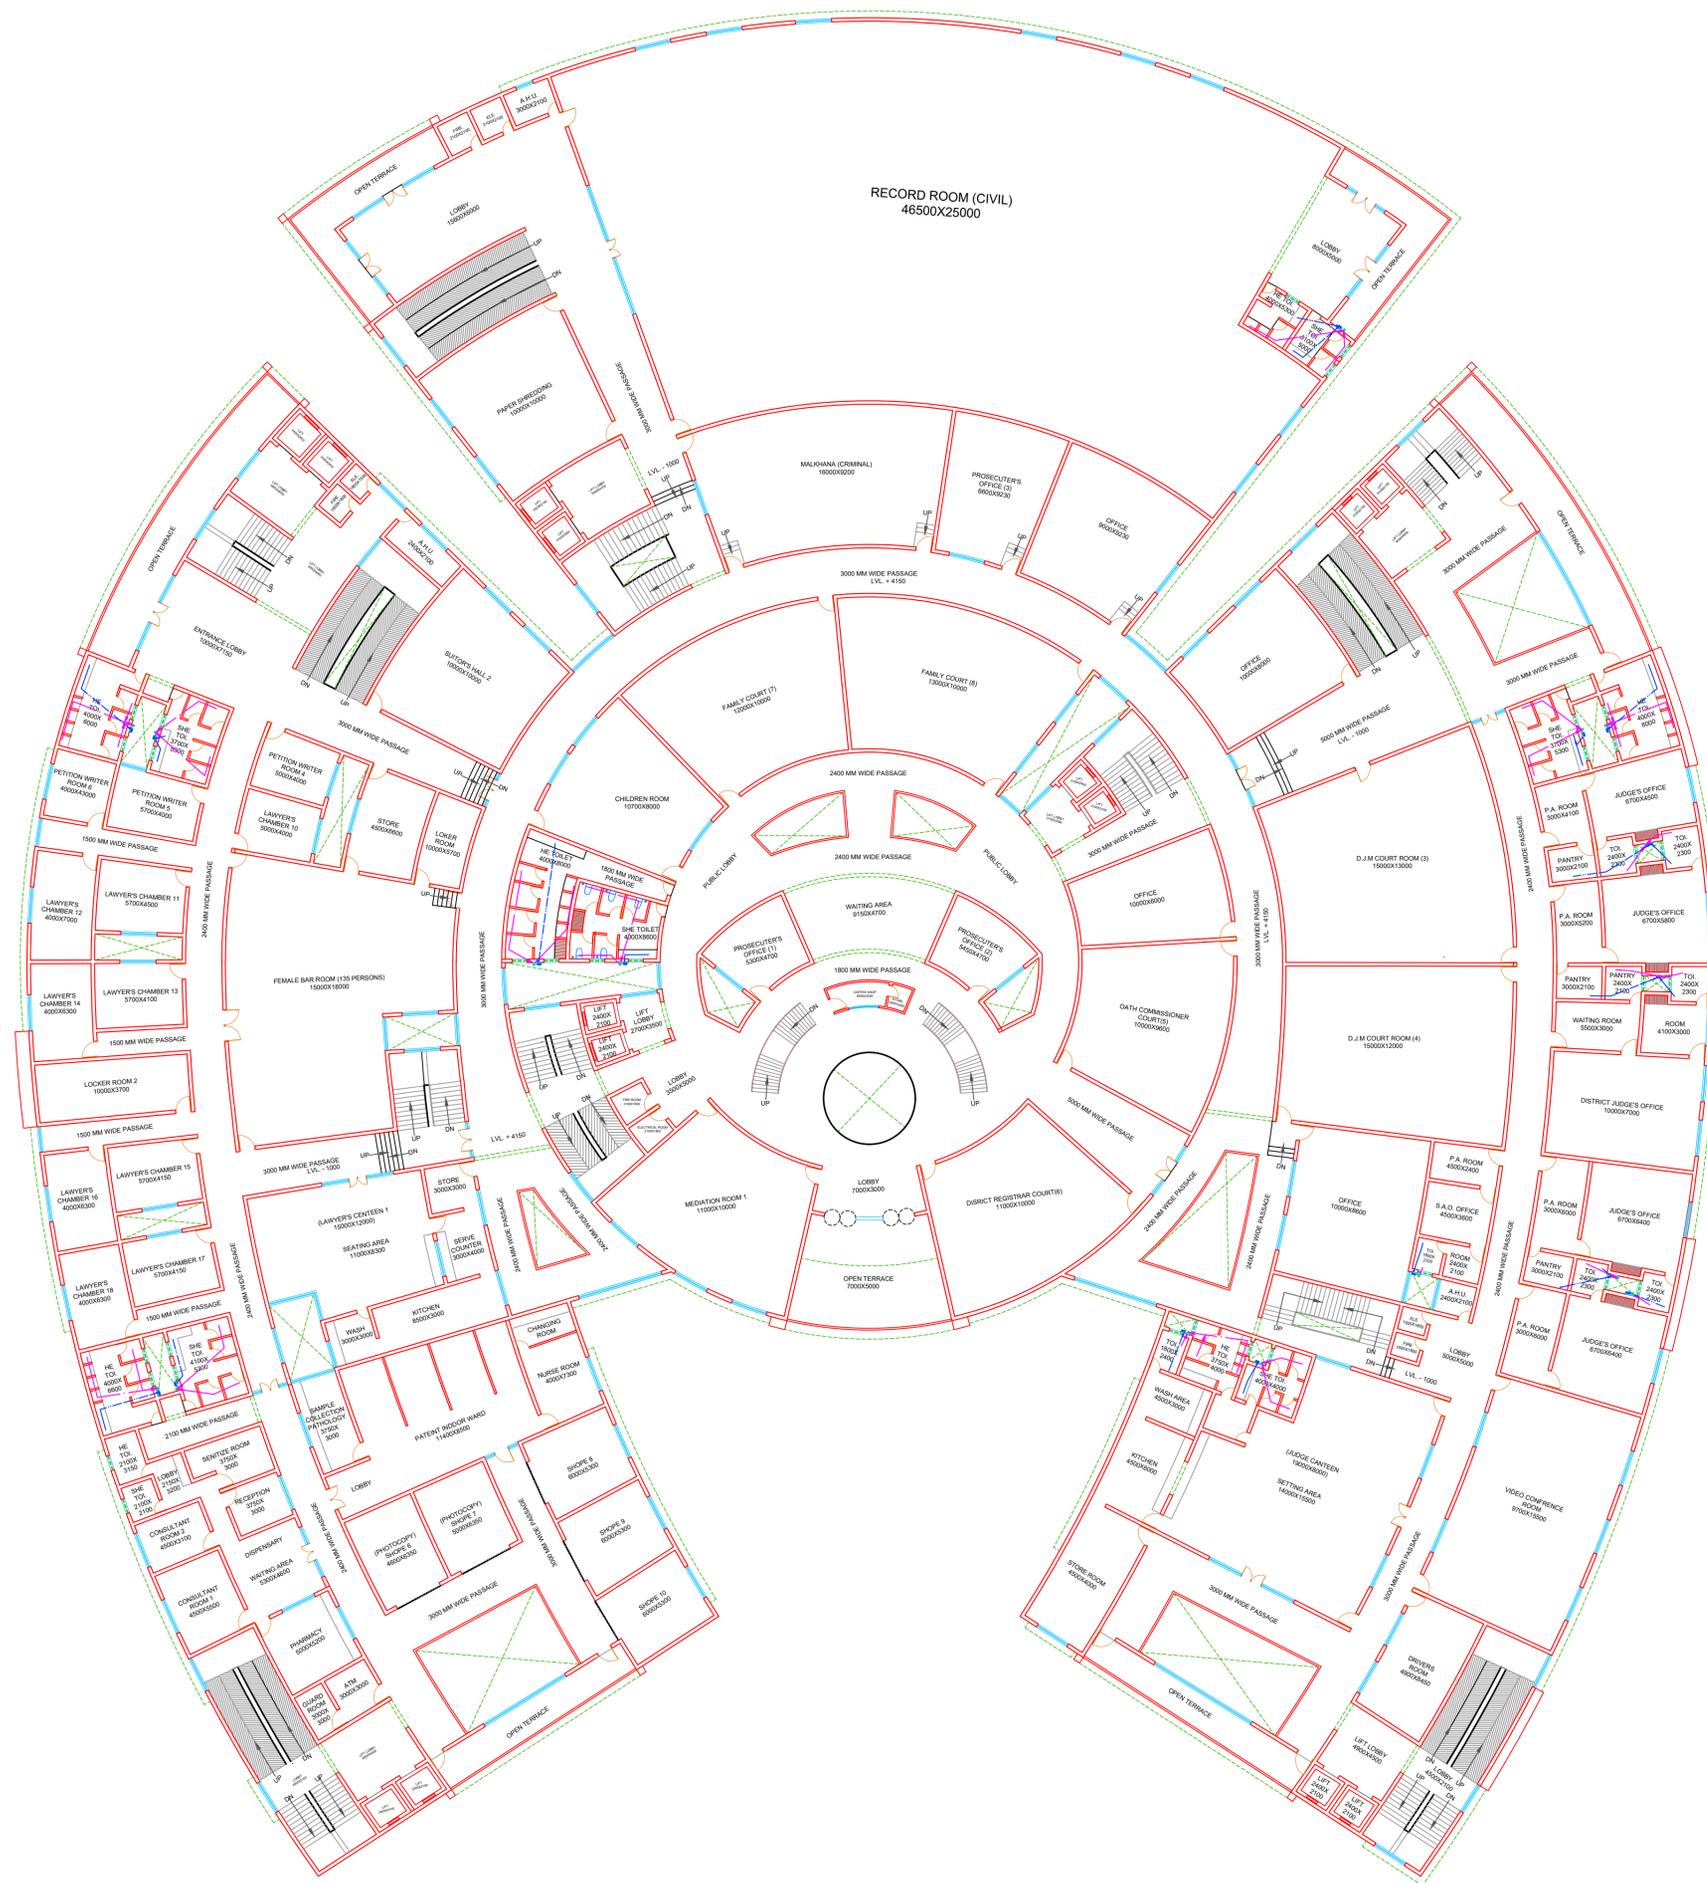

FIRST FLOOR PLAN



PROJECT TITLE

PROPOSED PLAN FOR  
'DISTRICT COURT COMPLEX  
AT DEHRADUN'



BYE LAWS :-  
SETBACKS  
FRONT = 15.00 M. G. COVERAGE ALLOWED = 35%  
REAR = 6.00 M. F.A.R. ALLOWED = 1.50  
SIDE - 1 = 6.00 M.  
SIDE - 2 = 6.00 M.

AREA STATEMENTS :-	
1. TOTAL PLOT AREA	= 26314.0 SQ. M. (= 6.30 ACRES)
2. PROPOSED COVERED AREA ON BASEMENT - 1 (SERVICES)	-- 9250.00 SQ.M.
3. PROPOSED COVERED AREA ON GROUND FLOOR	-- 7462.00 SQ.M.
4. PROPOSED COVERED AREA ON FIRST FLOOR	-- 7462.00 SQ.M.
5. PROPOSED COVERED AREA ON SECOND FLOOR	-- 7462.00 SQ.M.
6. PROPOSED COVERED AREA ON THIRD FLOOR	-- 7462.00 SQ.M.
7. PROP. COVD. AREA ON 4TH FL.	-- 7462.00 SQ.M.
8. PROP. COVD. AREA ON 5TH FL.	-- 53.00 SQ.M.
9. TOTAL COVERED AREA (IN F.A.R. - 12.50)	= 29901.00 SQ.M.
10. OPEN AREA ON GROUND FLOOR	-- 3063.00 SQ.M.
11. AREA OF PORCH	-- 290.62 SQ.M.
12. GROUND COVERAGE	-- 28.36 %
13. GREEN AREA	-- 17.3%
14. PROPOSED TOTAL PARKING	-- 345 ECS
15. AREA REQUIRED FOR @ 32 SQM. PER ECS.	-- 10880 SQM

**GENERAL NOTES**


All Dimensions are in mm. or specified

**SCALE**

**STUDENT DETAIL**  
Name - Poornima Raj Chaudhary  
Section - AR- 5-2  
Roll. No. - 1150101051

**SHEET NO.**

**GUIDE DETAIL**  
PR. MOHIT AGARWAL & AR. RAMAKANT

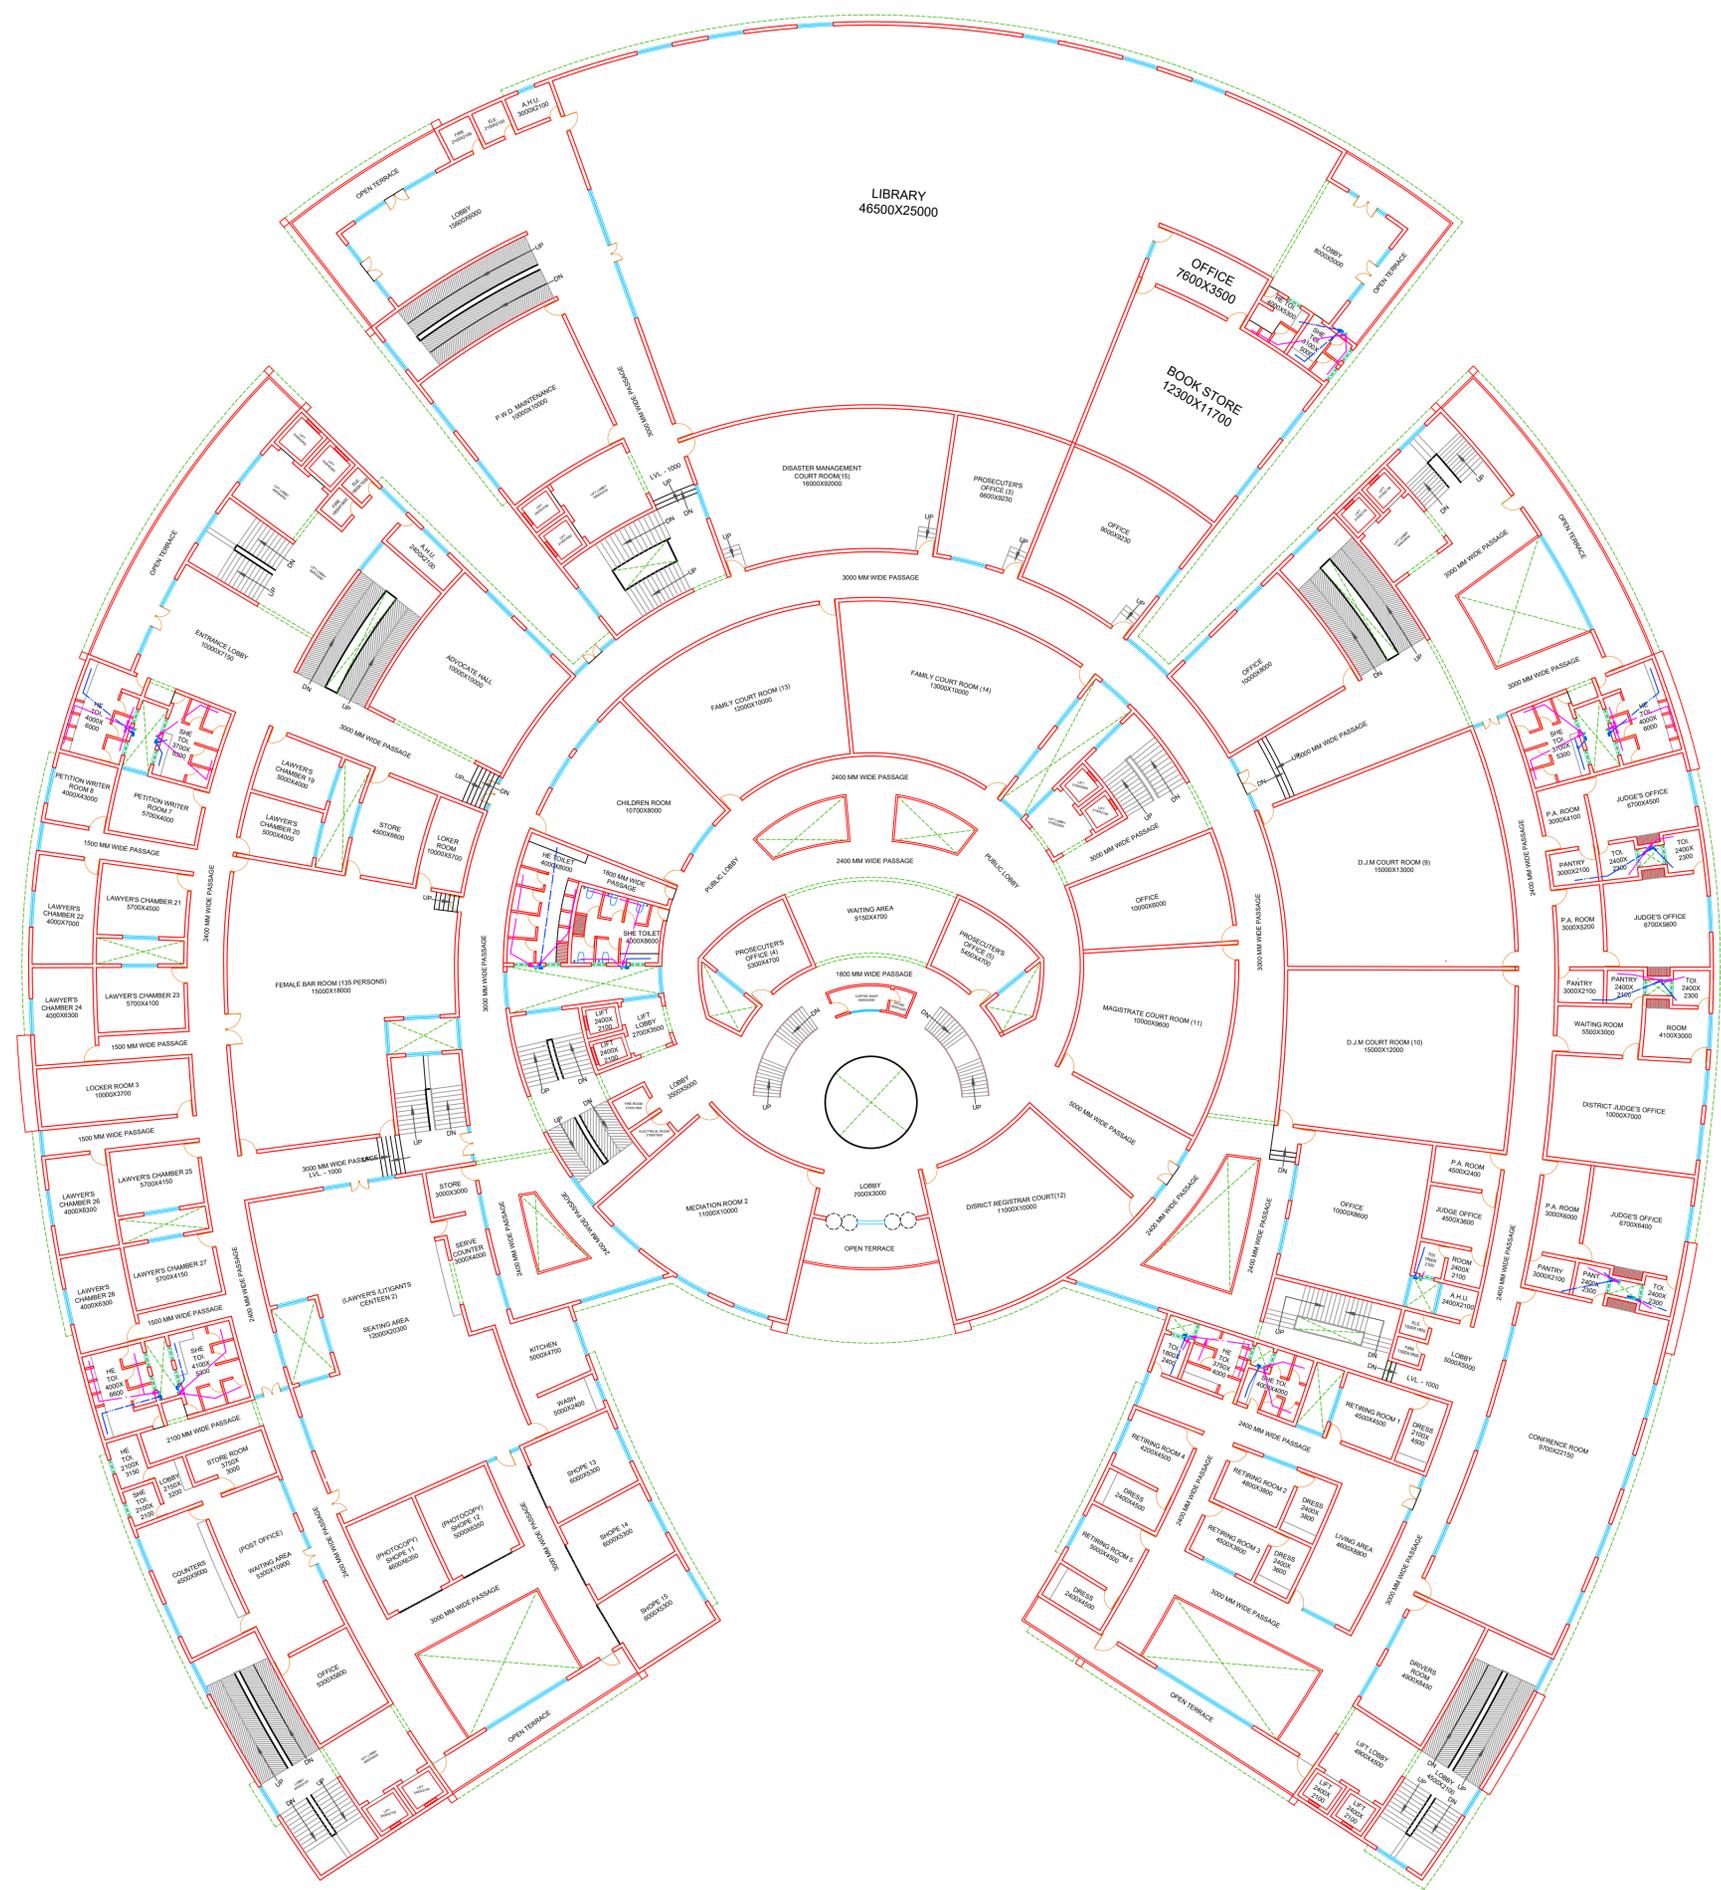

SECOND FLOOR PLAN



PROJECT TITLE

PROPOSED PLAN FOR  
'DISTRICT COURT COMPLEX  
AT DEHRADUN'



BYE LAWS :-

SETBACKS

FRONT = 15.00 M. G. COVERAGE ALLOWED = 35%

REAR = 6.00 M. F.A.R. ALLOWED = 1.50


SIDE - 1 = 6.00 M.

SIDE - 2 = 6.00 M.

AREA STATEMENTS :-

1.	TOTAL PLOT AREA	= 26314.0 SQ. M. (= 6.30 ACRES)
2.	PROPOSED COVERED AREA ON BASEMENT - 1 (SERVICES)	-- 9250.00 SQ.M.
3.	PROPOSED COVERED AREA ON GROUND FLOOR	-- 7462.00 SQ.M.
4.	PROPOSED COVERED AREA ON FIRST FLOOR	-- 7462.00 SQ.M.
5.	PROPOSED COVERED AREA ON SECOND FLOOR	-- 7462.00 SQ.M.
6.	PROPOSED COVERED AREA ON THIRD FLOOR	-- 7462.00 SQ.M.
7.	PROP. COVD. AREA ON 4TH FL.	-- 7462.00 SQ.M.
8.	PROP. COVD. AREA ON 5TH FL.	-- 53.00 SQ.M.
	TOTAL COVERED AREA	
9.	(IN F.A.R. - 12.50)	= 29901.00 SQ.M.
10.	OPEN AREA ON GROUND FLOOR	-- 3063.00 SQ.M.
11.	AREA OF PORCH	-- 290.62 SQ.M.
12.	GROUND COVERAGE	-- 28.36 %
13.	GREEN AREA	-- 17.3%
14.	PROPOSED TOTAL PARKING	-- 345 ECS
15.	AREA REQUIRED FOR @ 32 SQM. PER ECS.	-- 10880 SQM

NORTH

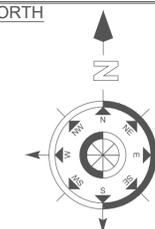

GENERAL NOTES

All Dimensions are in mm. or specified

SCALE


STUDENT DETAIL

Name - Poornima Raj  
Chaudhary  
Section - AR- 5-2  
Roll. No. - 1150101051

SHEET NO.

GUIDE DETAIL

PR. MOHIT AGARWAL  
&  
AR. RAMAKANT

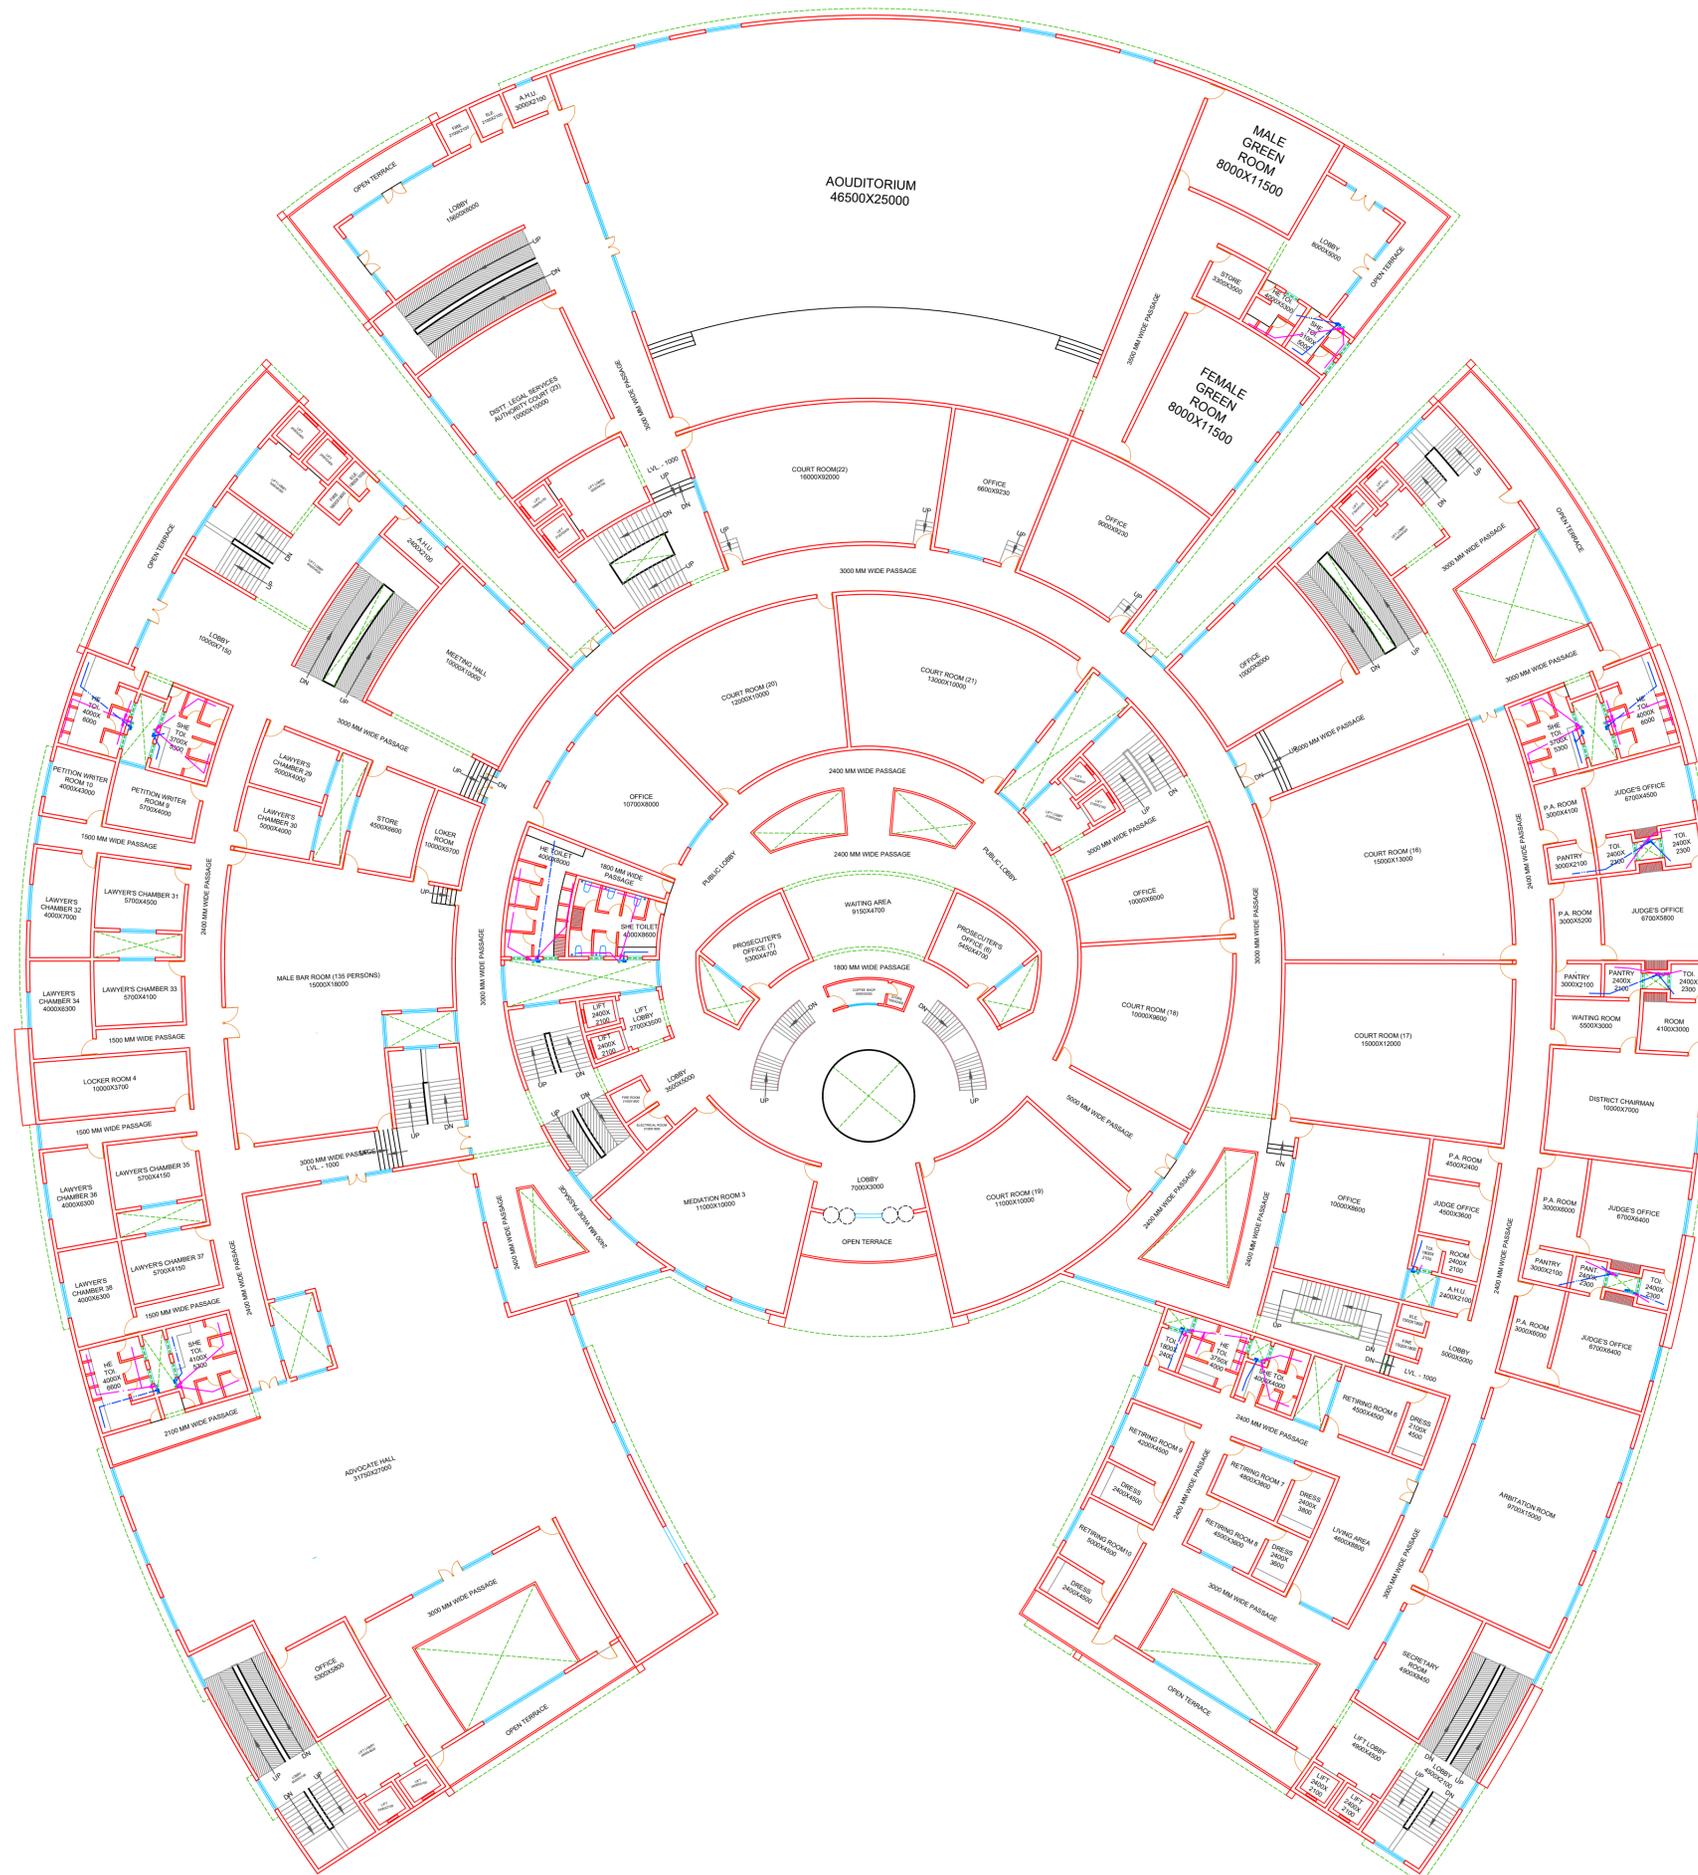

THIRD FLOOR PLAN



PROJECT TITLE

PROPOSED PLAN FOR  
'DISTRICT COURT COMPLEX  
AT DEHRADUN'




BYE LAWS :-  
SETBACKS

FRONT = 15.00 M. G. COVERAGE ALLOWED = 35%  
REAR = 6.00 M. F.A.R. ALLOWED = 1.50  
SIDE - 1 = 6.00 M.  
SIDE - 2 = 6.00 M.

AREA STATEMENTS :-

1.	TOTAL PLOT AREA	= 26314.0 SQ. M. (= 6.30 ACRES)
2.	PROPOSED COVERED AREA ON BASEMENT - 1 (SERVICES)	-- 9250.00 SQ.M.
3.	PROPOSED COVERED AREA ON GROUND FLOOR	-- 7462.00 SQ.M.
4.	PROPOSED COVERED AREA ON FIRST FLOOR	-- 7462.00 SQ.M.
5.	PROPOSED COVERED AREA ON SECOND FLOOR	-- 7462.00 SQ.M.
6.	PROPOSED COVERED AREA ON THIRD FLOOR	-- 7462.00 SQ.M.
7.	PROP. COVD. AREA ON 4TH FL.	-- 7462.00 SQ.M.
8.	PROP. COVD. AREA ON 5TH FL.	-- 53.00 SQ.M.
9.	TOTAL COVERED AREA (IN F.A.R. - 12.50)	= 29901.00 SQ.M.
10.	OPEN AREA ON GROUND FLOOR	-- 3063.00 SQ.M.
11.	AREA OF PORCH	-- 290.62 SQ.M.
12.	GROUND COVERAGE	-- 28.36 %
13.	GREEN AREA	-- 17.3%
14.	PROPOSED TOTAL PARKING	-- 345 ECS
15.	AREA REQUIRED FOR @ 32 SQM. PER ECS.	-- 10880 SQM

NORTH

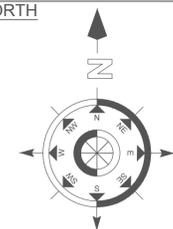

GENERAL NOTES

All Dimensions are in mm. or specified

SCALE


STUDENT DETAIL

Name - Poornima Raj Chaudhary  
Section - AR- 5-2  
Roll. No. - 1150101051

SHEET NO.

GUIDE DETAIL

PR. MOHIT AGARWAL & AR. RAMAKANT

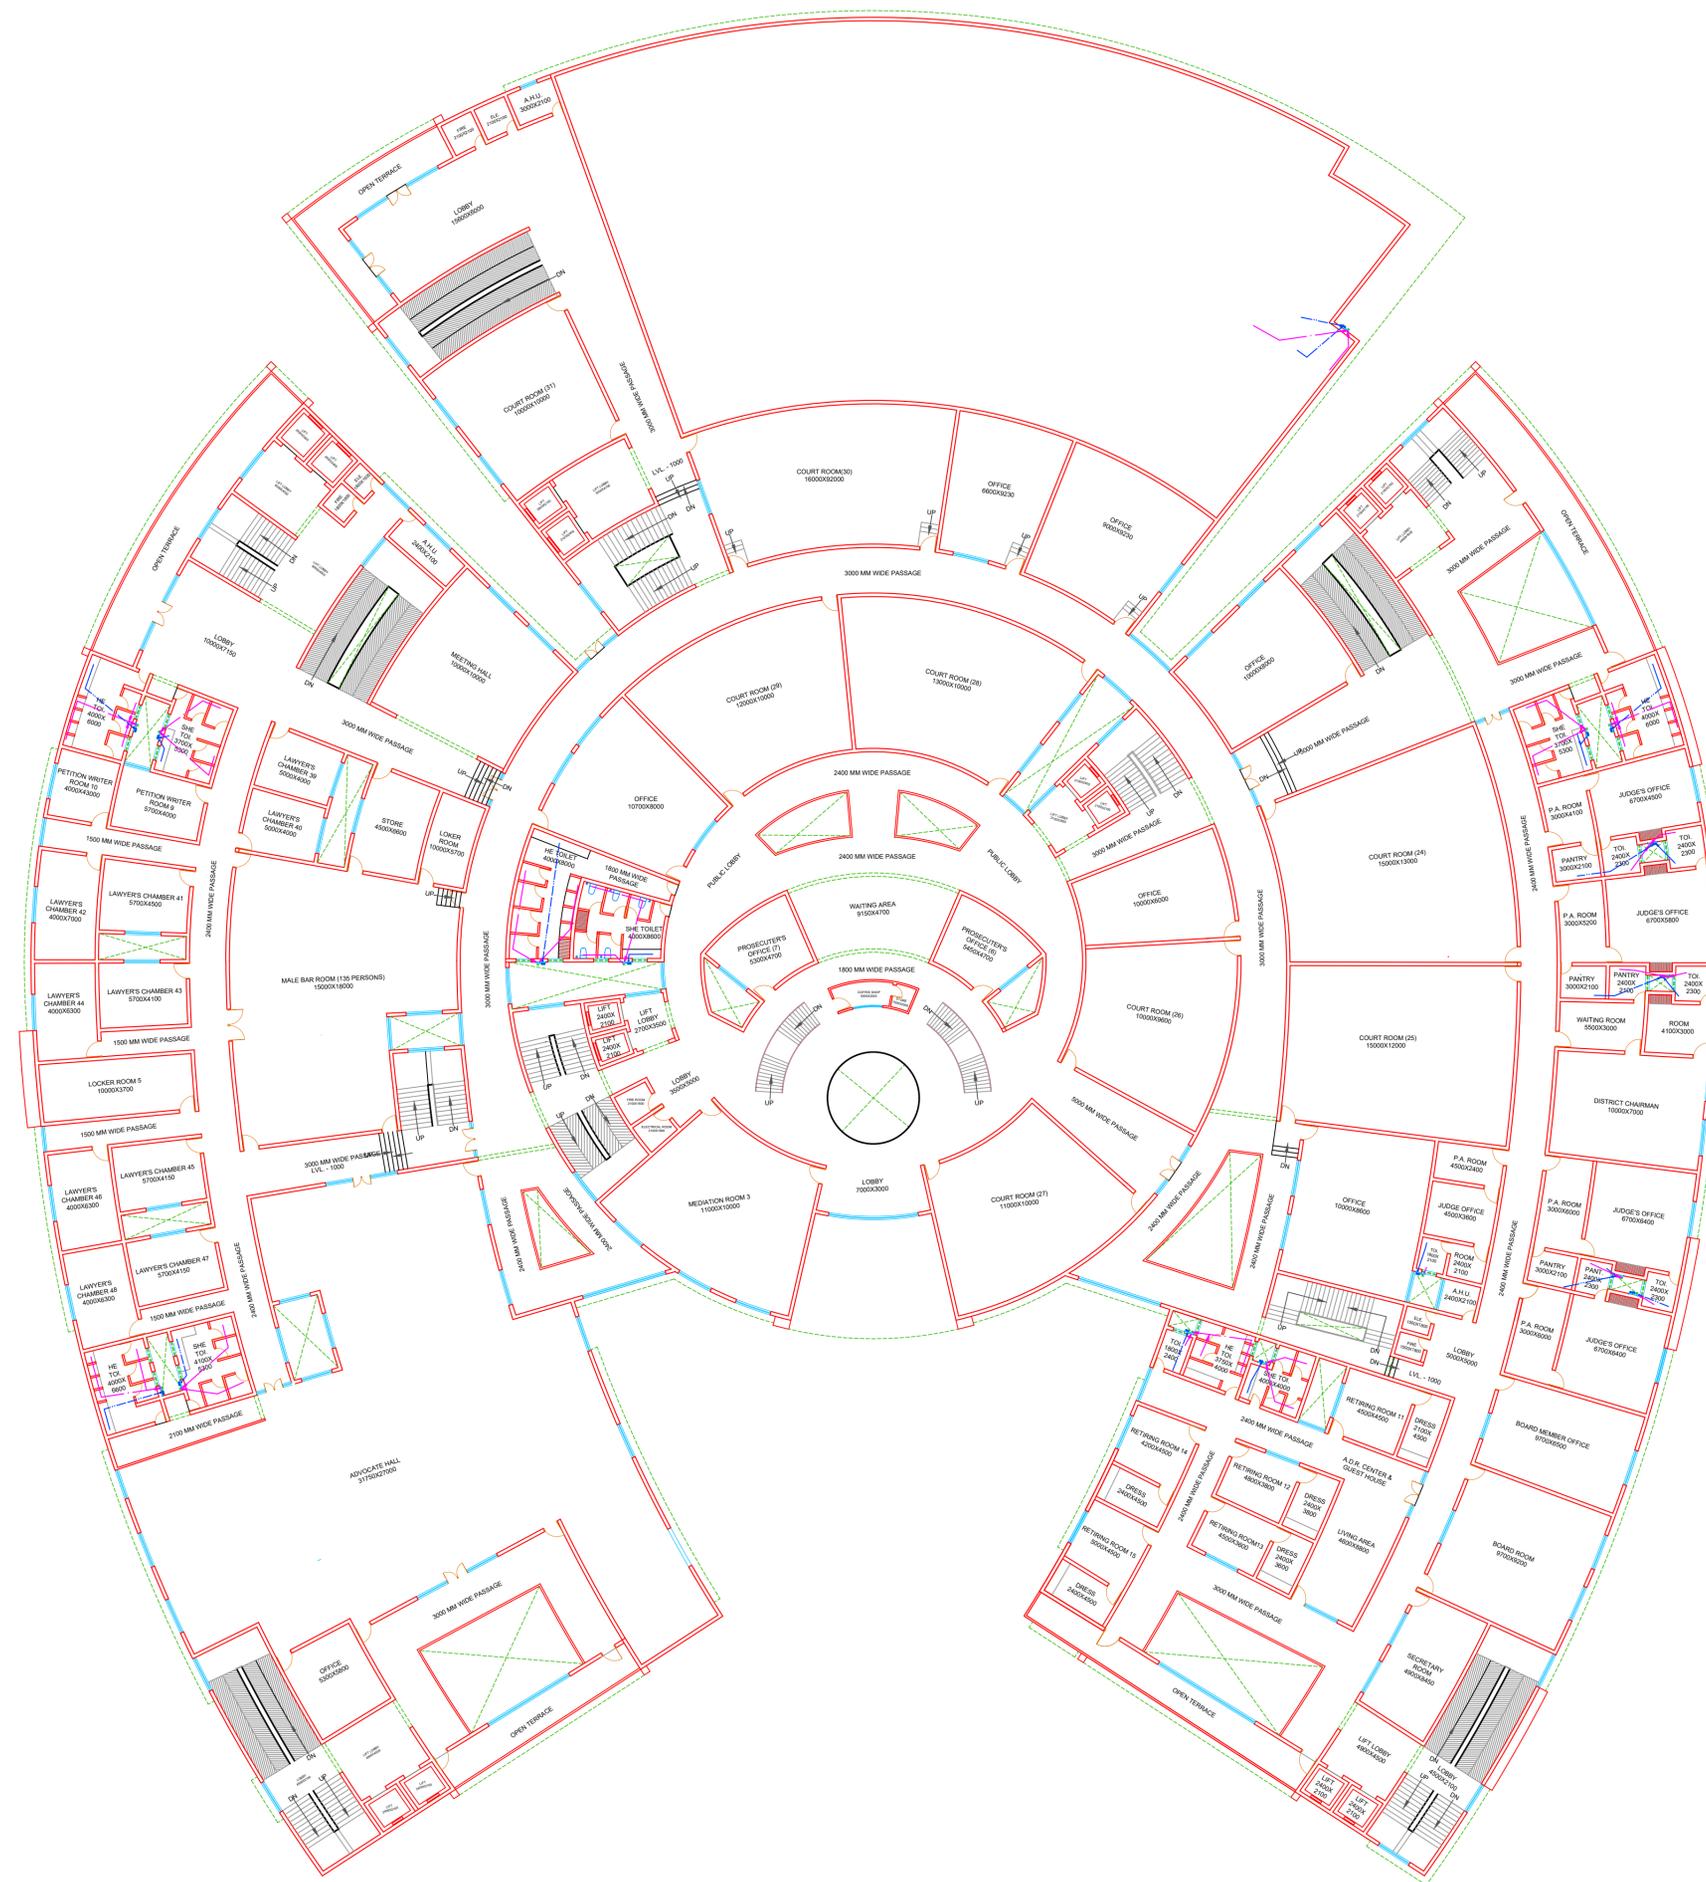

FOURTH FLOOR PLAN



PROJECT TITLE

PROPOSED PLAN FOR  
'DISTRICT COURT COMPLEX  
AT DEHRADUN'




BYE LAWS :-  
SETBACKS

FRONT = 15.00 M. | G. COVERAGE ALLOWED = 35%  
REAR = 6.00 M. | F.A.R. ALLOWED = 1.50  
SIDE - 1 = 6.00 M.  
SIDE - 2 = 6.00 M.

AREA STATEMENTS :-

1.	TOTAL PLOT AREA	= 26314.0 SQ. M. (= 6.30 ACRES)
2.	PROPOSED COVERED AREA ON BASEMENT - 1 (SERVICES)	-- 9250.00 SQ.M.
3.	PROPOSED COVERED AREA ON GROUND FLOOR	-- 7462.00 SQ.M.
4.	PROPOSED COVERED AREA ON FIRST FLOOR	-- 7462.00 SQ.M.
5.	PROPOSED COVERED AREA ON SECOND FLOOR	-- 7462.00 SQ.M.
6.	PROPOSED COVERED AREA ON THIRD FLOOR	-- 7462.00 SQ.M.
7.	PROP. COVD. AREA ON 4TH FL.	-- 7462.00 SQ.M.
8.	PROP. COVD. AREA ON 5TH FL.	-- 53.00 SQ.M.
9.	TOTAL COVERED AREA (IN F.A.R. - 12.50)	= 29901.00 SQ.M.
10.	OPEN AREA ON GROUND FLOOR	-- 3063.00 SQ.M.
11.	AREA OF PORCH	-- 290.62 SQ.M.
12.	GROUND COVERAGE	-- 28.36 %
13.	GREEN AREA	-- 17.3%
14.	PROPOSED TOTAL PARKING	-- 345 ECS
15.	AREA REQUIRED FOR @ 32 SQM. PER ECS.	-- 10880 SQM

NORTH

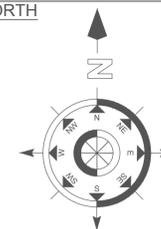

GENERAL NOTES

All Dimensions are in mm. or specified

SCALE


STUDENT DETAIL

Name - Poornima Raj Chaudhary  
Section - AR- 5-2  
Roll. No. - 1150101051

SHEET NO.

GUIDE DETAIL

PR. MOHIT AGARWAL & AR. RAMAKANT

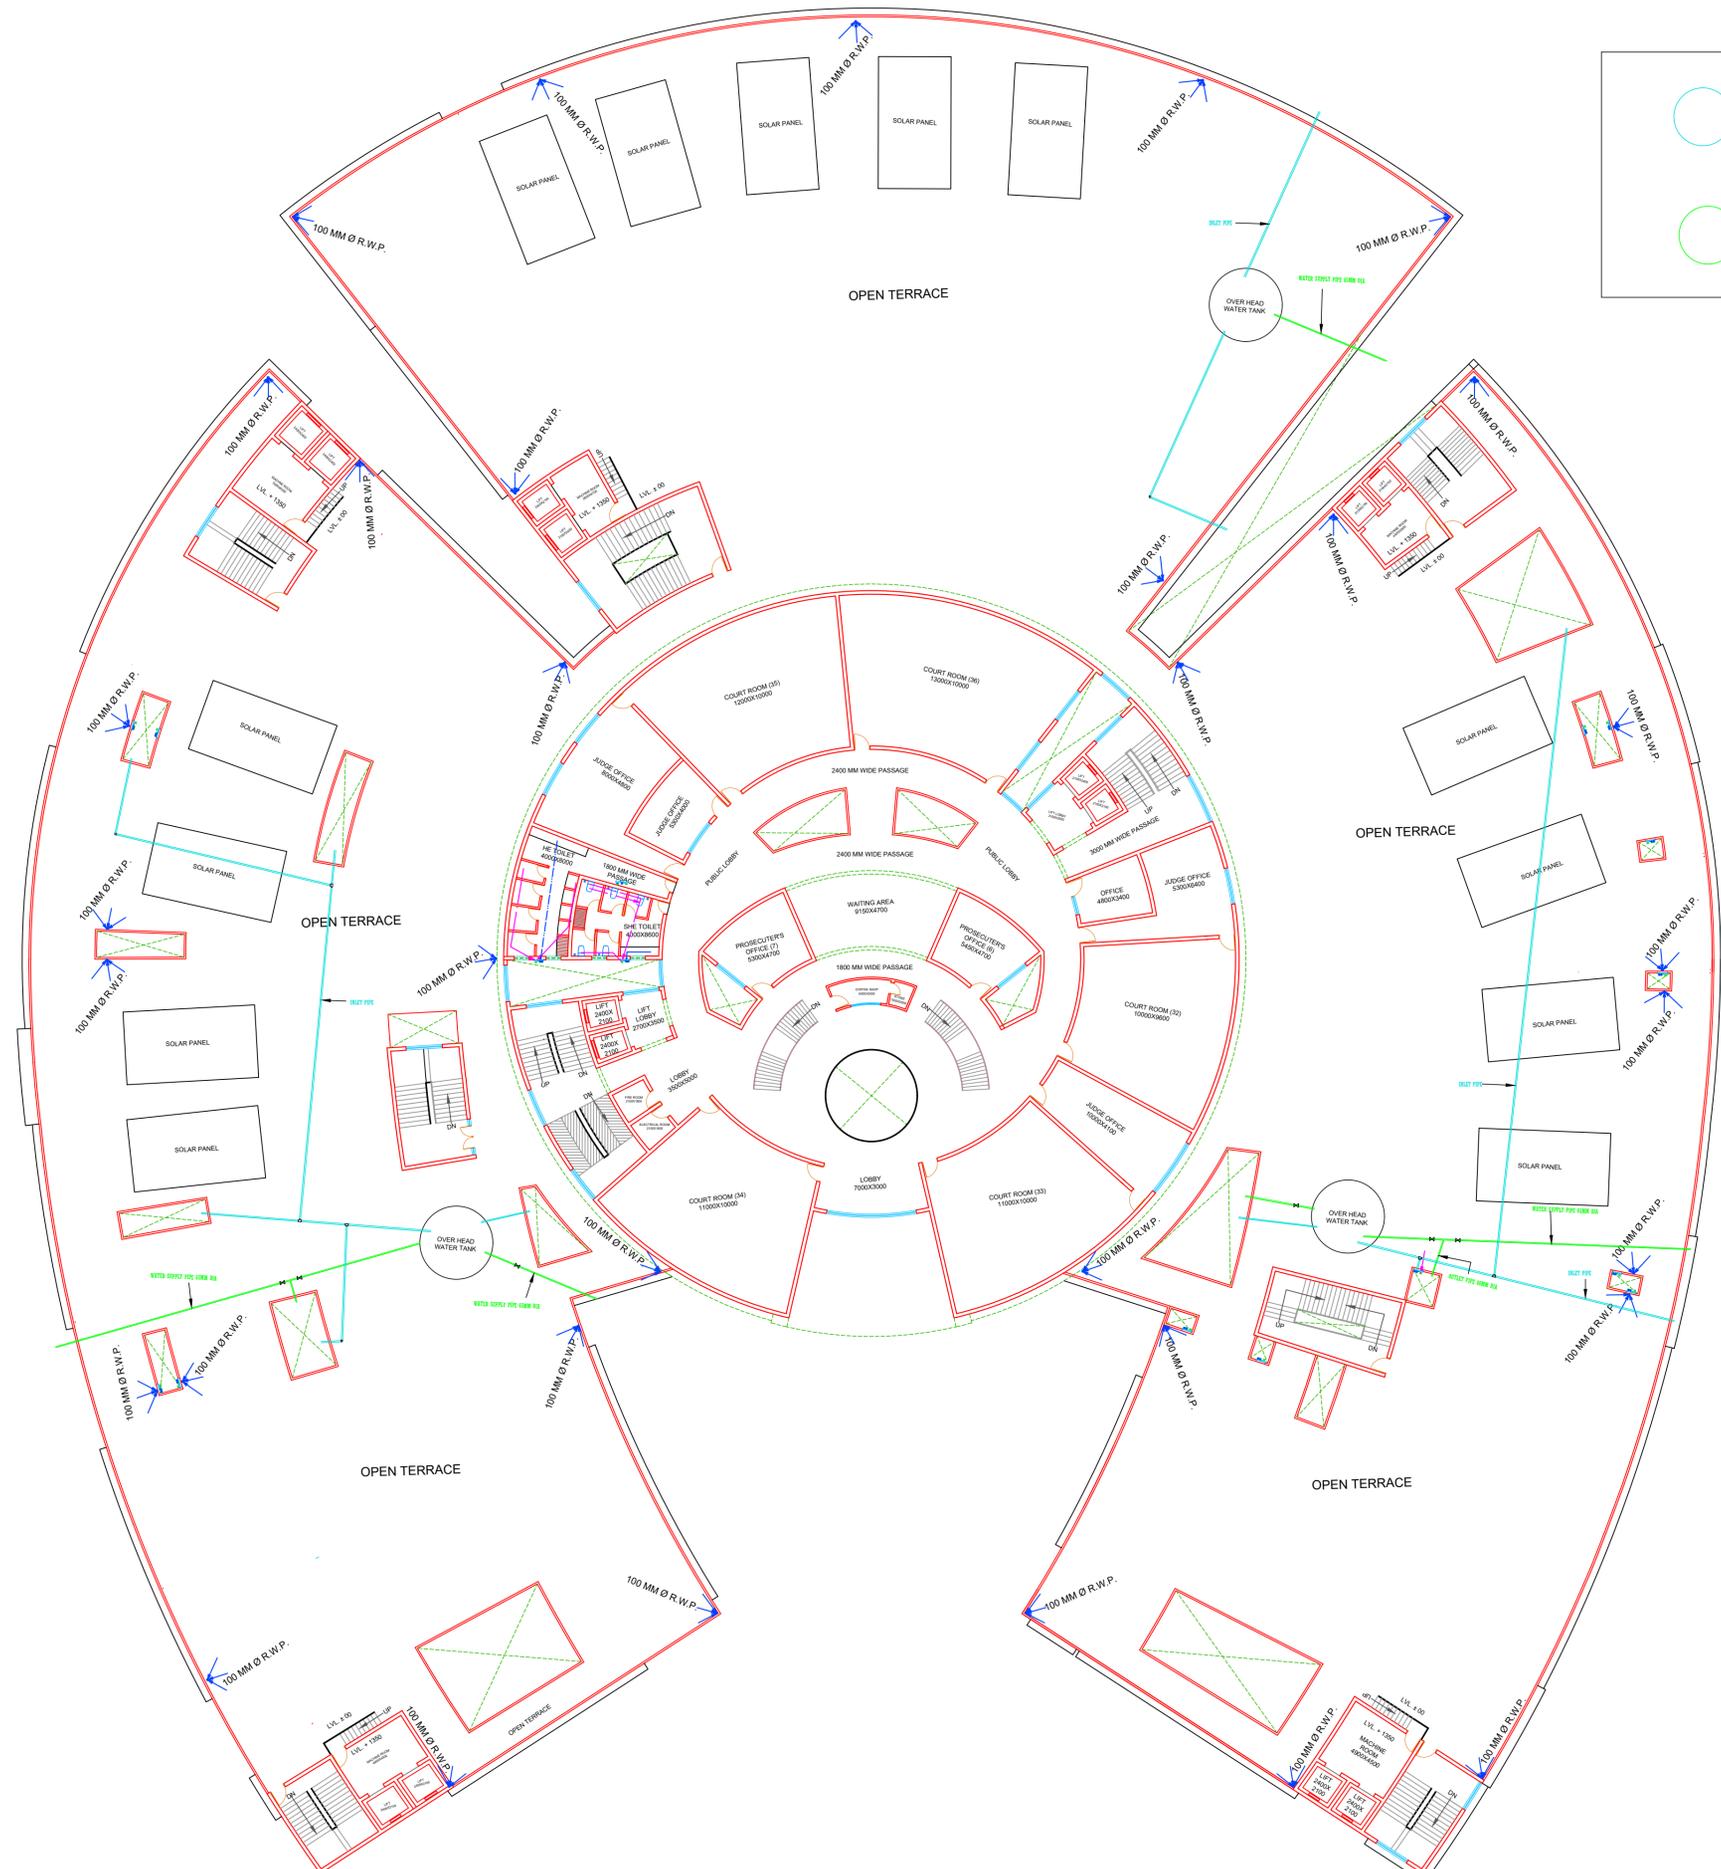

FIFTH FLOOR PLAN



PROJECT TITLE

PROPOSED PLAN FOR  
'DISTRICT COURT COMPLEX  
AT DEHRADUN'




BYE LAWS :-  
SETBACKS

FRONT = 15.00 M.	G. COVERAGE ALLOWED = 35%
REAR = 6.00 M.	F.A.R. ALLOWED = 1.50
SIDE - 1 = 6.00 M.	
SIDE - 2 = 6.00 M.	

AREA STATEMENTS :-

1. TOTAL PLOT AREA	= 26314.0 SQ. M. (= 6.30 ACRES)
2. PROPOSED COVERED AREA ON BASEMENT - 1 (SERVICES)	-- 9250.00 SQ.M.
3. PROPOSED COVERED AREA ON GROUND FLOOR	-- 7462.00 SQ.M.
4. PROPOSED COVERED AREA ON FIRST FLOOR	-- 7462.00 SQ.M.
5. PROPOSED COVERED AREA ON SECOND FLOOR	-- 7462.00 SQ.M.
6. PROPOSED COVERED AREA ON THIRD FLOOR	-- 7462.00 SQ.M.
7. PROP. COVD. AREA ON 4TH FL.	-- 7462.00 SQ.M.
8. PROP. COVD. AREA ON 5TH FL.	-- 53.00 SQ.M.
9. TOTAL COVERED AREA (IN F.A.R. - 12.50)	= 29901.00 SQ.M.
10. OPEN AREA ON GROUND FLOOR	-- 3063.00 SQ.M.
11. AREA OF PORCH	-- 290.62 SQ.M.
12. GROUND COVERAGE	-- 28.36 %
13. GREEN AREA	-- 17.3%
14. PROPOSED TOTAL PARKING	-- 345 ECS
15. AREA REQUIRED FOR @ 32 SQM. PER ECS.	-- 10880 SQM

NORTH

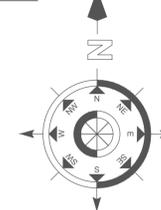

GENERAL NOTES

All Dimensions are in mm. or specified

SCALE



STUDENT DETAIL

Name - Poornima Raj Chaudhary  
Section - AR- 5-2  
Roll. No. - 1150101051

SHEET NO.

GUIDE DETAIL

PR. MOHIT AGARWAL & AR. RAMAKANT

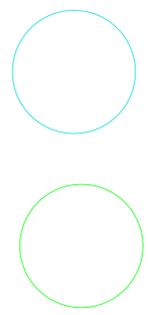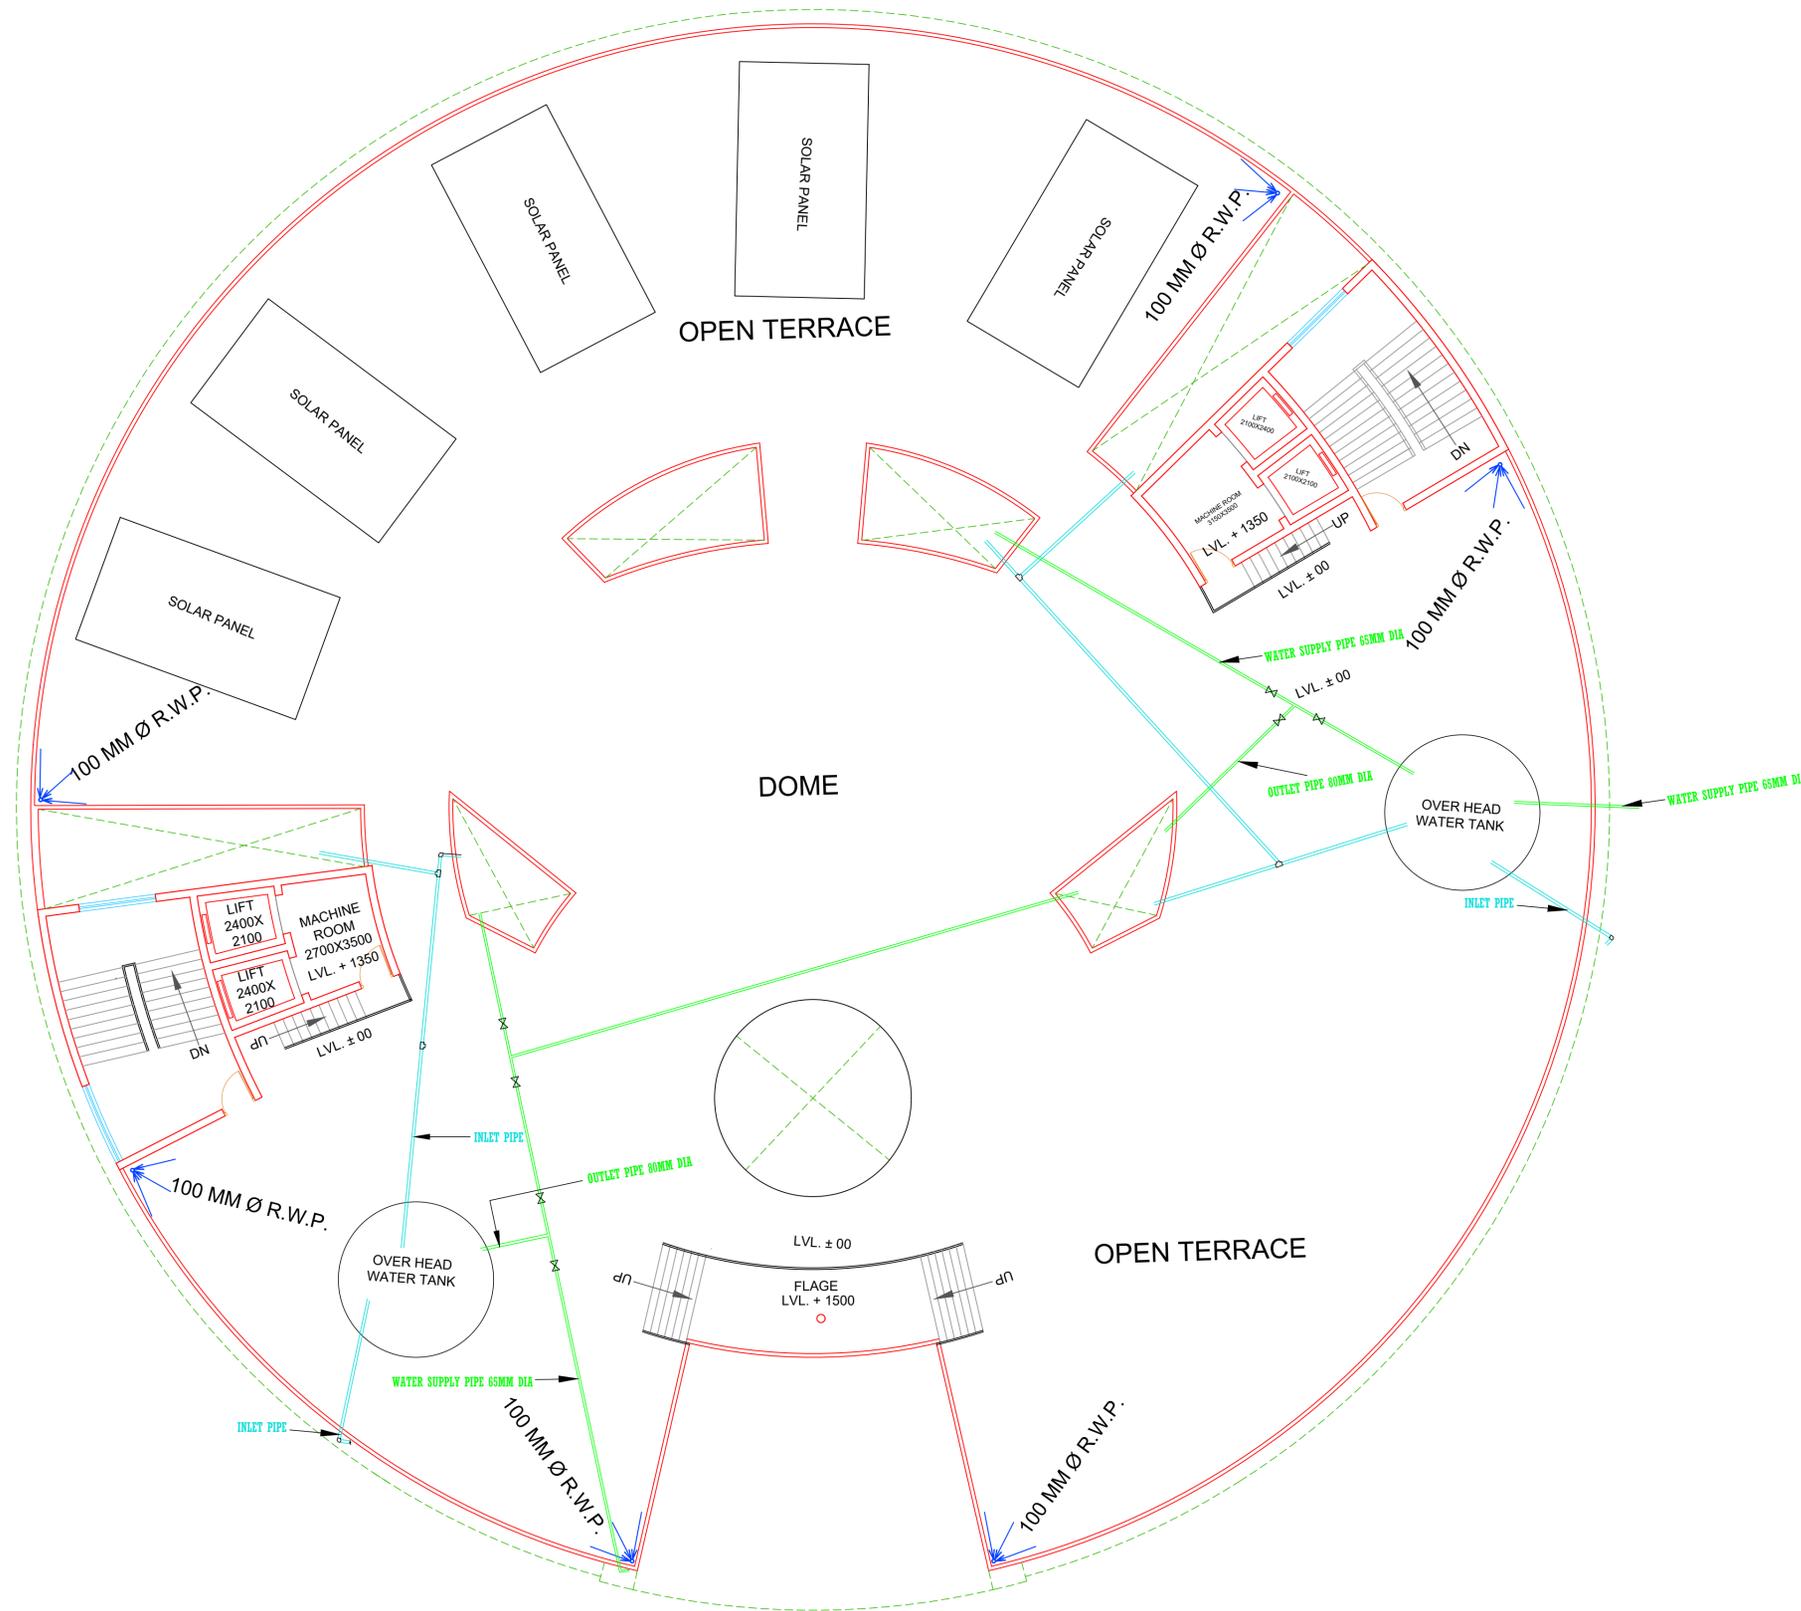

TERRACE PLAN





PROJECT TITLE

PROPOSED PLAN FOR  
'DISTRICT COURT COMPLEX  
AT DEHRADUN'




BYE LAWS :-  
SETBACKS

FRONT = 15.00 M. | G. COVERAGE ALLOWED = 35%  
REAR = 6.00 M. | F.A.R. ALLOWED = 1.50  
SIDE - 1 = 6.00 M.  
SIDE - 2 = 6.00 M.

AREA STATEMENTS :-

1. TOTAL PLOT AREA	= 26314.0 SQ. M. (= 6.30 ACRES)
2. PROPOSED COVERED AREA ON BASEMENT - 1 (SERVICES)	-- 9250.00 SQ.M.
3. PROPOSED COVERED AREA ON GROUND FLOOR	-- 7462.00 SQ.M.
4. PROPOSED COVERED AREA ON FIRST FLOOR	-- 7462.00 SQ.M.
5. PROPOSED COVERED AREA ON SECOND FLOOR	-- 7462.00 SQ.M.
6. PROPOSED COVERED AREA ON THIRD FLOOR	-- 7462.00 SQ.M.
7. PROP. COVD. AREA ON 4TH FL.	-- 7462.00 SQ.M.
8. PROP. COVD. AREA ON 5TH FL.	-- 53.00 SQ.M.
9. TOTAL COVERED AREA (IN F.A.R. - 12.50)	= 29901.00 SQ.M.
10. OPEN AREA ON GROUND FLOOR	-- 3063.00 SQ.M.
11. AREA OF PORCH	-- 290.62 SQ.M.
12. GROUND COVERAGE	-- 28.36 %
13. GREEN AREA	-- 17.3%
14. PROPOSED TOTAL PARKING	-- 345 ECS
15. AREA REQUIRED FOR @ 32 SQM. PER ECS.	-- 10880 SQM

NORTH

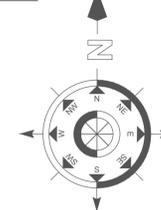

GENERAL NOTES

All Dimensions are in mm. or specified

SCALE


STUDENT DETAIL

Name - Poornima Raj Chaudhary  
Section - AR- 5-2  
Roll. No. - 1150101051


SHEET NO.

GUIDE DETAIL


PR. MOHIT AGARWAL & AR. RAMAKANT

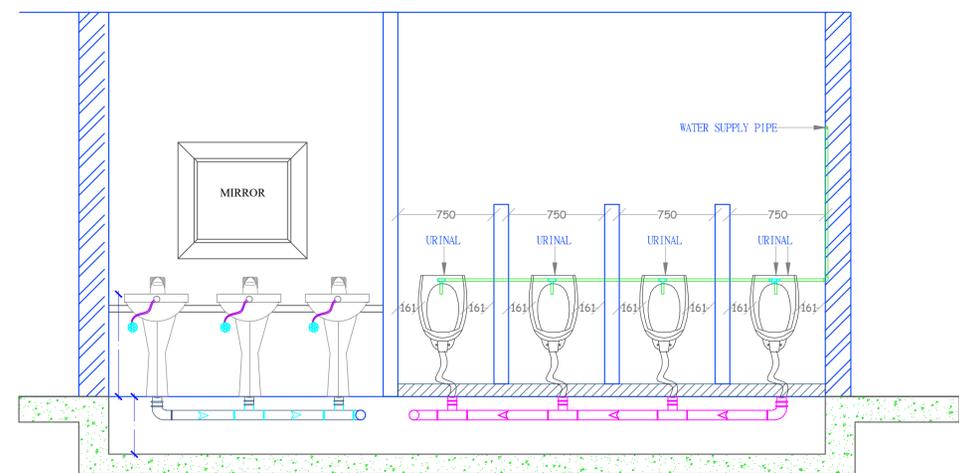


SECTION AA

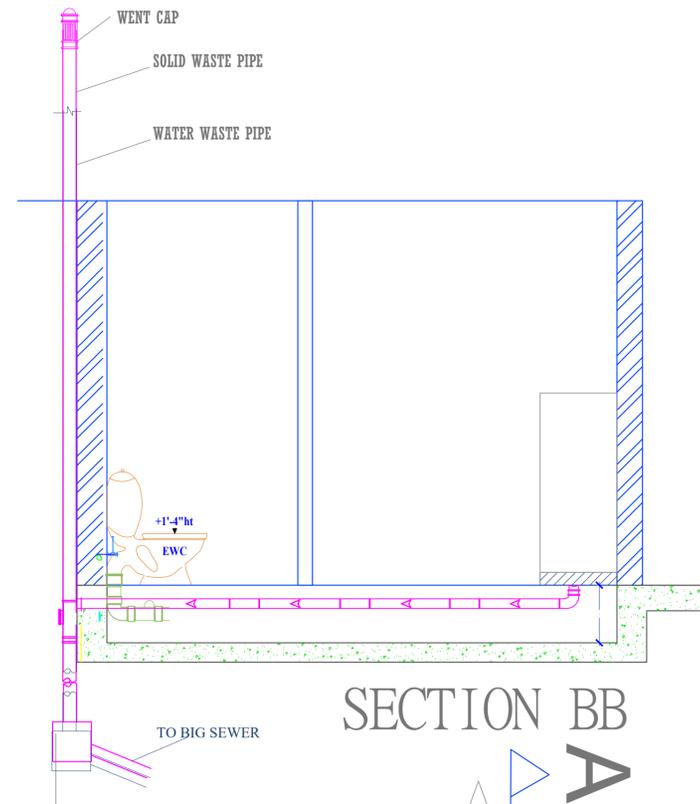

SECTION BB

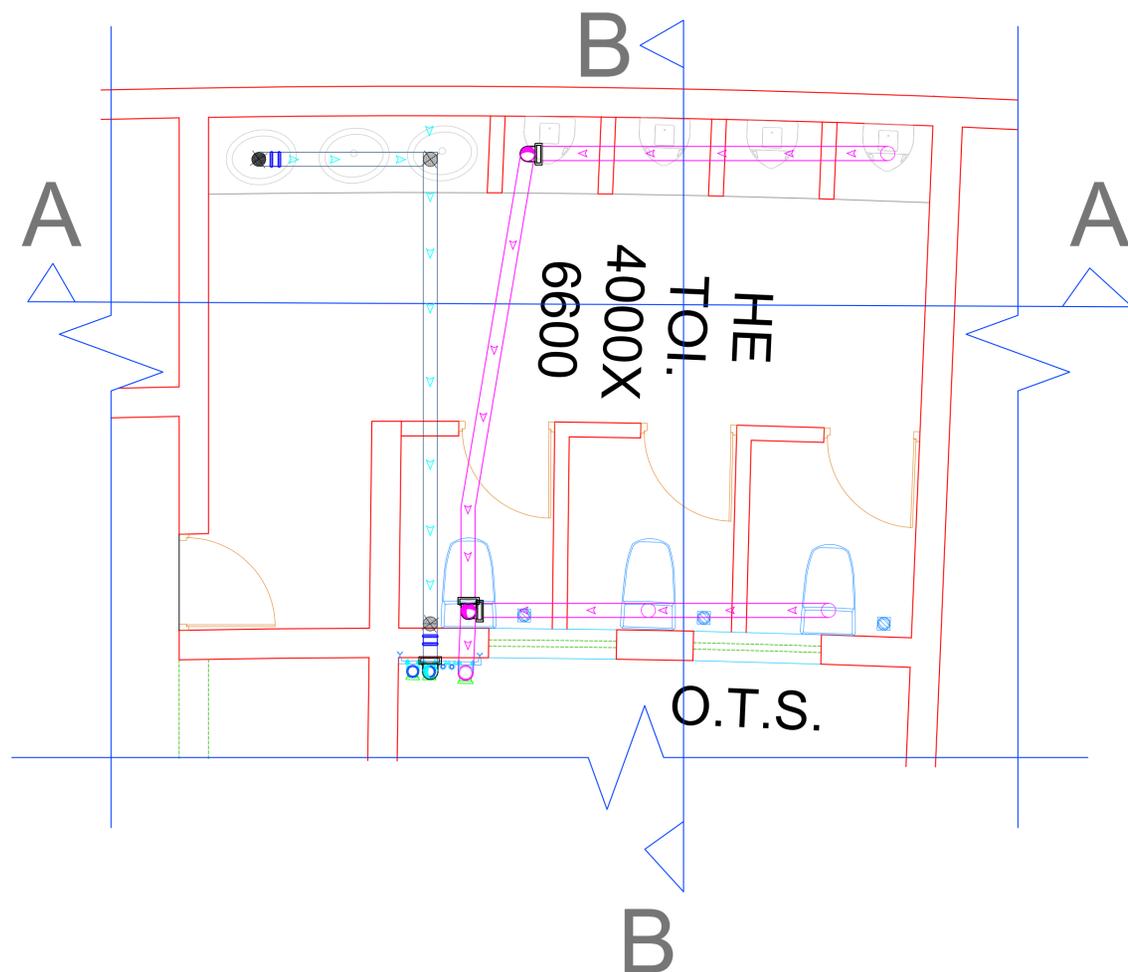


TYPICAL TOILET DETAIL

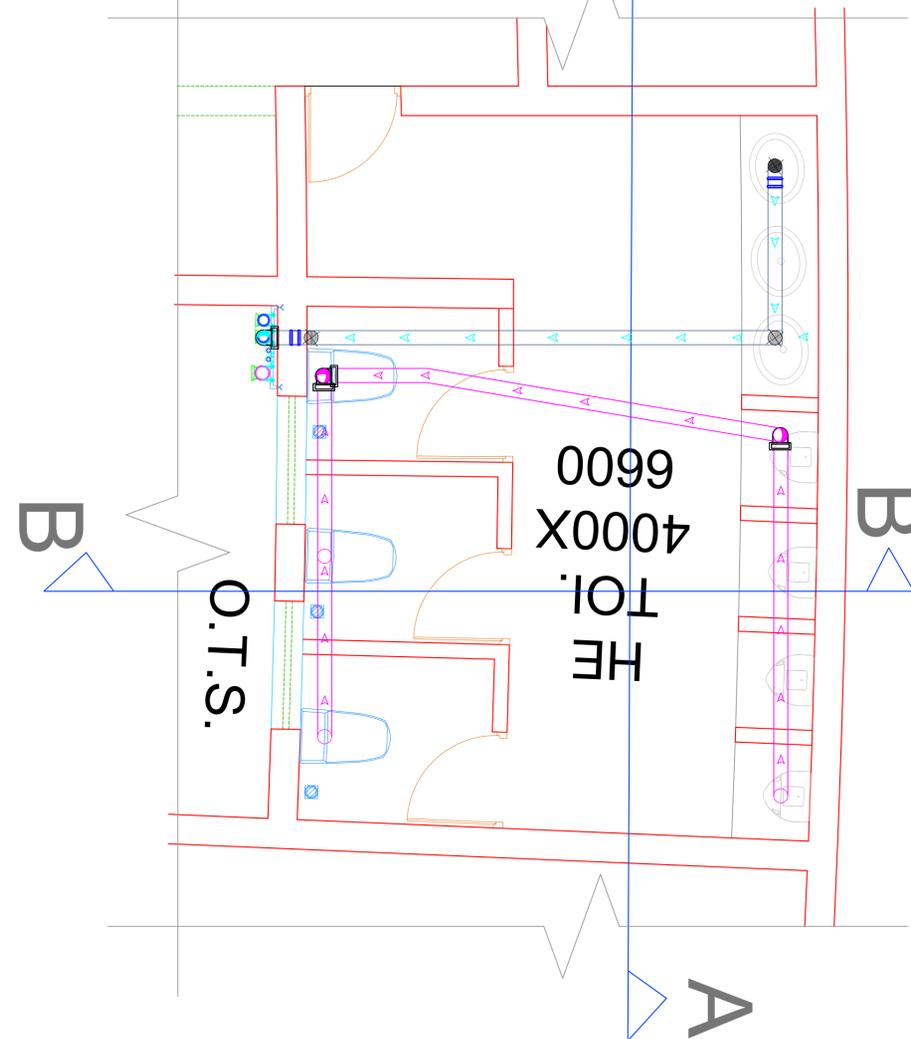

LEGENED:

S.NO	BOTANICAL NAME	LOCAL NAME	HEIGHT / SHAPE	FOLIAGE	FLOWERING	SPECIAL FEATURE	USES
1.	DELONIA REGIA	GULMOHAR	15 TO 18M UMBRELLA SHAPED	LIGHT FEATHERY 15 TO 20 CM PINNAE	SCARLET RED ORANGE SPURLED AT 15° APR-JUN	EVERGREEN QUICK GROWING	EAST PERIPHERY ALONG JUDGE BLOCK
2.	SPATHODEA CAMPANULATA	AMALTAS	8 TO 10M HIGH	LIGHT FEATHERY 15 TO 20 CM PINNAE	SCARLET RED ORANGE SPURLED AT 15° APR-JUN	EVERGREEN QUICK GROWING	ALONG SOUTH & WEST PERIPHERY FOR SHADE
3.	BARCA INDICA	ASHOKA	20M TALL COLUMNAR	LARGE, 50 TO 60 CM LEAVES 4 TO 6 CM LONG	WHITE CYLINDRICAL OR SPURLED FRAGRANCE AND FLOWERING BEGINS FEB TO APRIL	EVERGREEN QUICK GROWING	ALONG NORTH WEST PERIPHERY OF PREMISES
4.		QUEEN OF NIGHTS	LARGE SHRUB	LEAVES ALTERNATE OVAL TO OVAL LONG TRICORDATE	CREAMY WHITE FLOWERS SCARLET NIGHTS 20 CM LONG TRICORDATE BLOSSOMS SUMMER AND RAIN	EVERGREEN	OVER EARTH MOONSHADE FOR ROAD

5.	KADIRACHTA INDICA	NEEM	10 TO 15M SPHERICAL	DELICATE BRINY 20 TO 30 CM SCOTED	YELLOW IN WINTER	MEDICINAL PURPOSE, SLOW GROWING	SHADE FOR STOUT P.W.A.T.
6.	ANTHOCEPHALUS CADAMBA	KADAMBA	10 TO 15 M TALL CYLINDRICAL	DELICATE BRINY 20 TO 30 CM SCOTED	YELLOW ORANGE IN WINTER	MEDICINAL PURPOSE, SLOW GROWING	SHADE FOR ROAD & BICYCLE
7.	HIBISCUS ROSA SINENSIS	CHINA ROSE	1 TO 3M	OVATE COMPLEX TOOTHED	LARGE WHITE/ RED/ ORANGE COLOURED	USED AS HEDGE	AROUND SWIMMING POOL
8.	CHRYSANTHEMUM	SADABAHAR	40 TO 60 CM	SMALL GREEN	WHITE/ YELLOW/ PINK/ PURPLE & WHITE NUMEROUS PETALS		AROUND PARKING AND WATER BODY
9.	THESPESIA PORNIFERA	PARAS PIPAL	6-10 M TALL CORDATE SHAPED	DULL GREEN	WHITE/ YELLOW/ PINK/ PURPLE & WHITE NUMEROUS PETALS		AROUND ROAD FOR SHADING
10.	FIGUS INFECTORIA	PAKUR	30M HT. CORDATE SHAPED	10 TO 17 CM LONG LEAVES, DENSE	GREEN BLOSSOMING TO PURPLE	SEMI EVERGREEN	SHADE FOR PARKING
11.	DELONIA REGIA	GULMOHAR	15 TO 18M UMBRELLA SHAPED				IT IS A TREE THAT IS LARGELY GROWN FOR ITS BEAUTY. THE WOOD WHICH IS WHITE AND SOFT IS USED FOR MAKING ORNAMENTS, AND CAN BE VERY HEAVY. FLOWERS THE FLOWERS AND BLOSSOMS ARE USED (AS A HERB) FOR FLAVOURING FOOD.

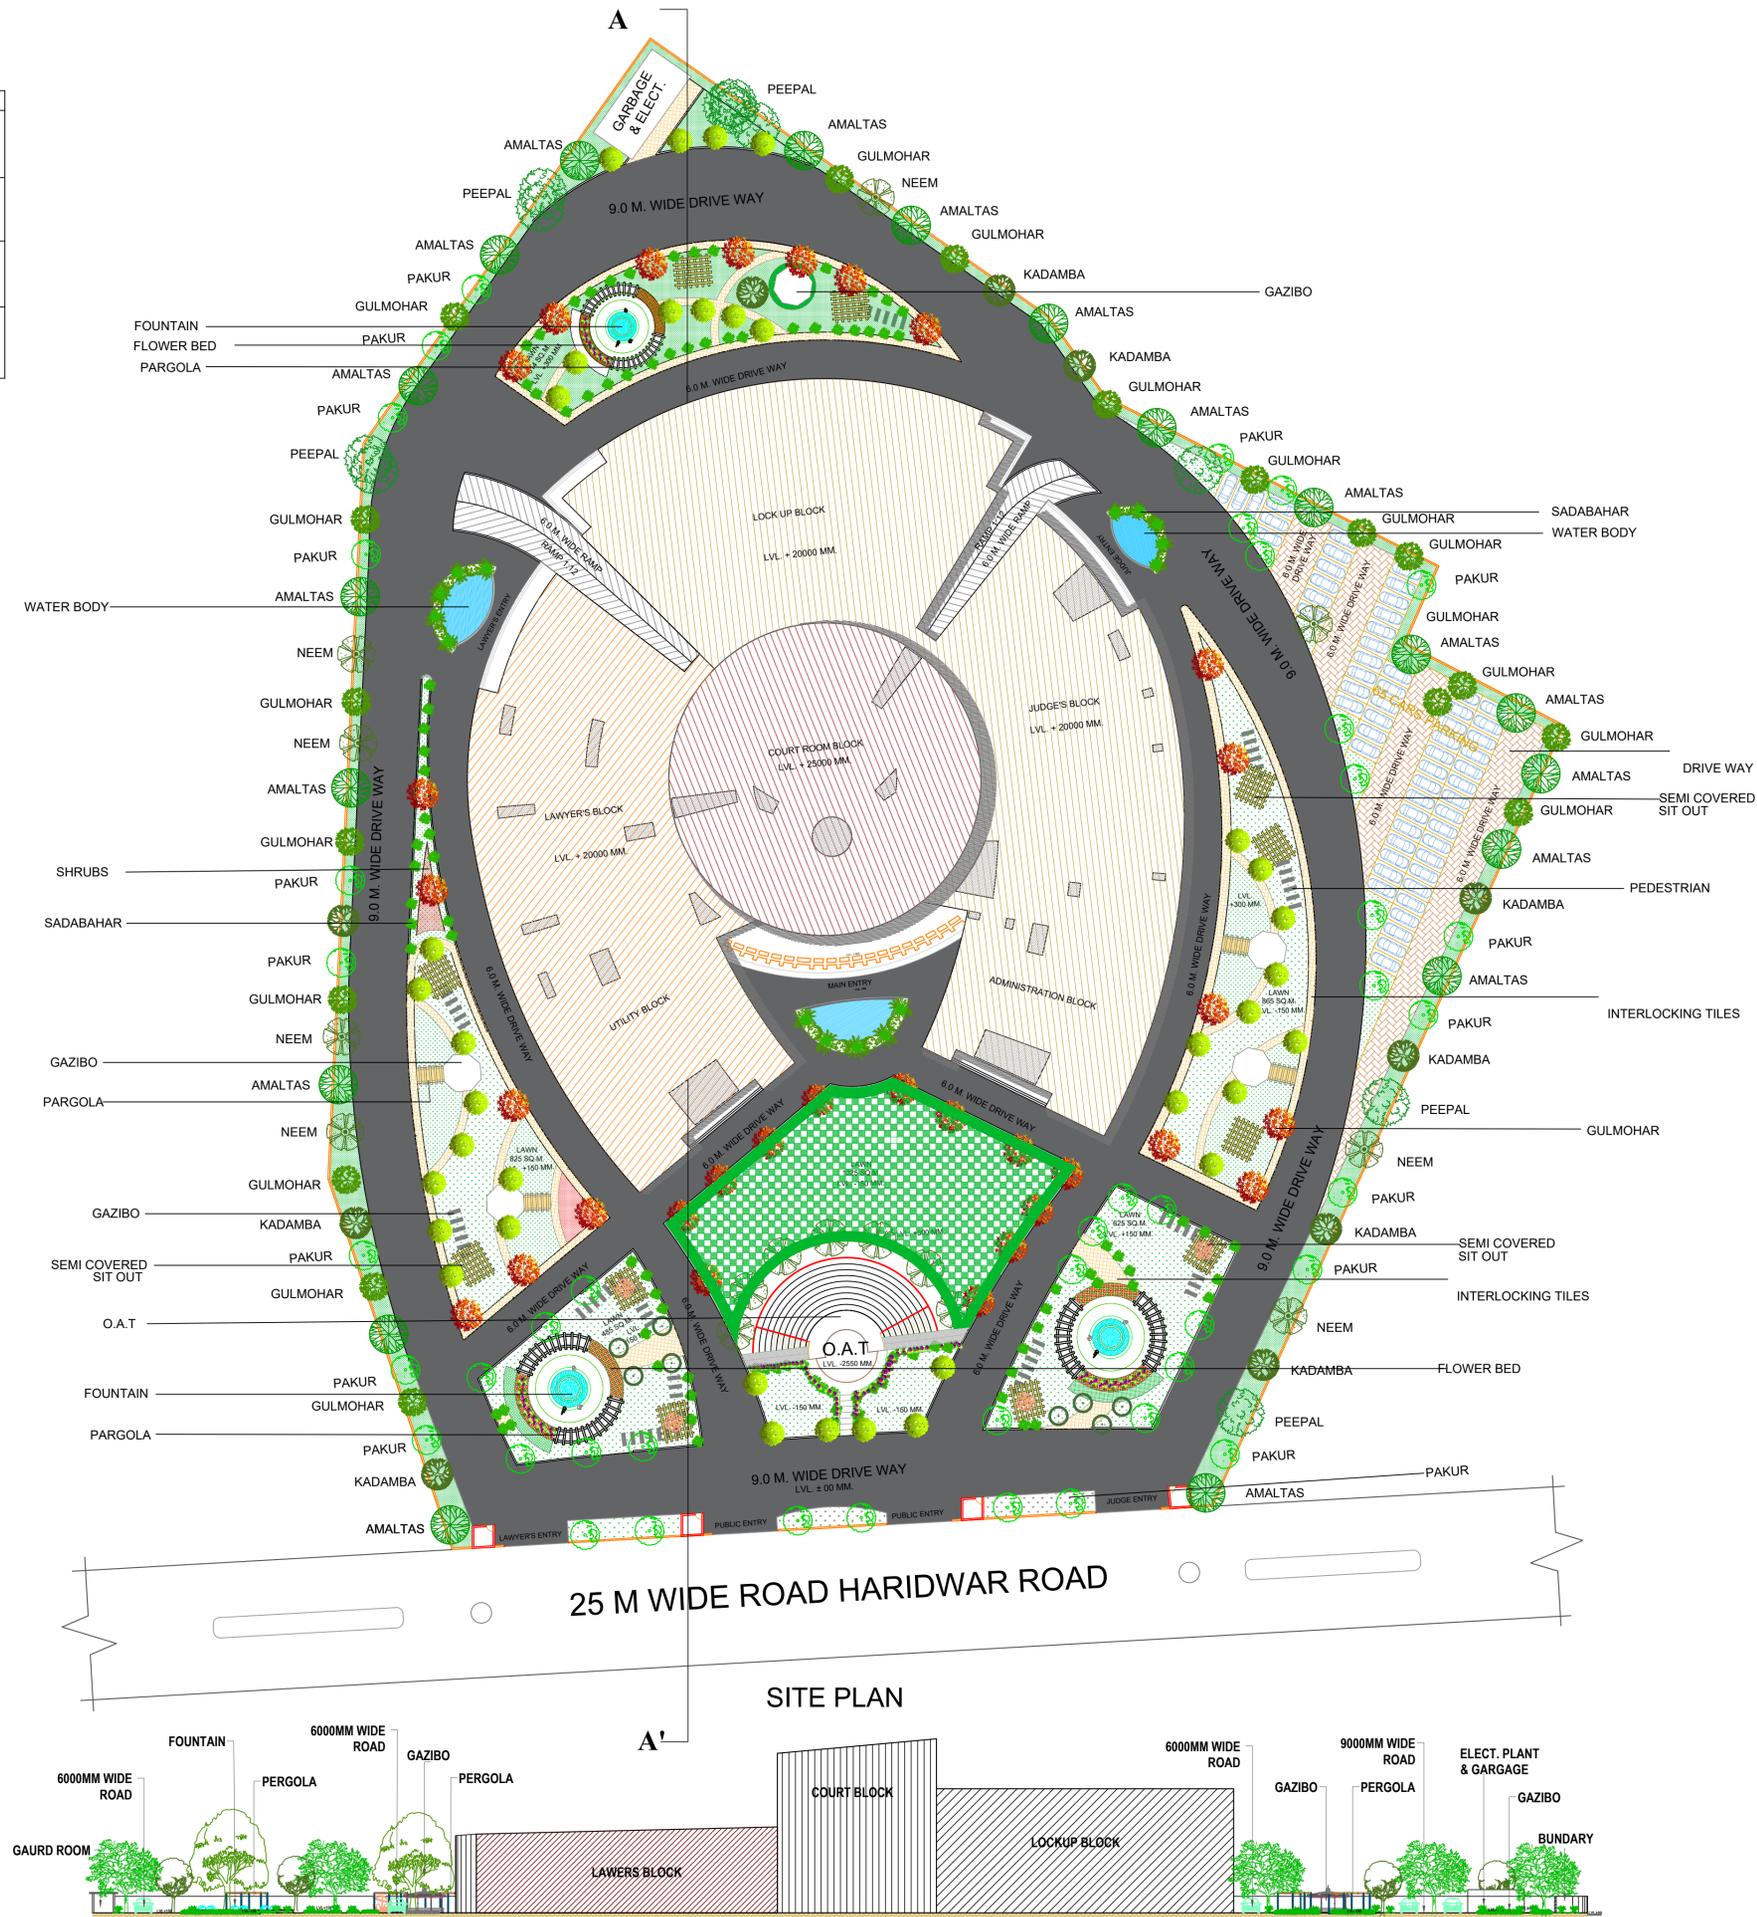

PROJECT TITLE

PROPOSED PLAN FOR 'DISTRICT COURT COMPLEX AT DEHRADUN'



BYE LAWS :-  
**SETBACKS**  
 FRONT = 15.00 M. G. COVERAGE ALLOWED = 35%  
 REAR = 6.00 M. F.A.R. ALLOWED = 1.50  
 SIDE - 1 = 6.00 M.  
 SIDE - 2 = 6.00 M.


**AREA STATEMENTS :-**

1.	TOTAL PLOT AREA	= 26314.0 SQ. M. (6.30 ACRES)
2.	PROPOSED COVERED AREA ON BASEMENT - 1 (SERVICES)	-- 9250.00 SQ.M.
3.	PROPOSED COVERED AREA ON GROUND FLOOR	-- 7462.00 SQ.M.
4.	PROPOSED COVERED AREA ON FIRST FLOOR	-- 7462.00 SQ.M.
5.	PROPOSED COVERED AREA ON SECOND FLOOR	-- 7462.00 SQ.M.
6.	PROPOSED COVERED AREA ON THIRD FLOOR	-- 7462.00 SQ.M.
7.	PROP. COVD. AREA ON 4TH FL.	-- 7462.00 SQ.M.
8.	PROP. COVD. AREA ON 5TH FL.	-- 53.00 SQ.M.
9.	TOTAL COVERED AREA (IN F.A.R. - 12.50)	= 29901.00 SQ.M.
10.	OPEN AREA ON GROUND FLOOR	-- 3063.00 SQ.M.
11.	AREA OF PORCH	-- 290.62 SQ.M.
12.	GROUND COVERAGE	-- 28.36 %
13.	GREEN AREA	-- 17.3%
14.	PROPOSED TOTAL PARKING	-- 345 ECS
15.	AREA REQUIRED FOR @ 32 SQM. PER ECS.	-- 10880 SQM

**GENERAL NOTES**  
 All Dimensions are in mm. or specified

SCALE	STUDENT DETAIL
	Name - Poornima Raj Chaudhary Section - AR- 5-2 Roll. No. - 1150101051


SHEET NO.	GUIDE DETAIL
	PR. MOHIT AGARWAL & AR. RAMAKANT

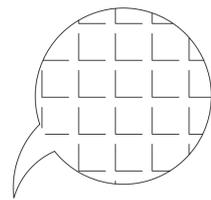

PLAN


Concrete Tile, as Specified,  
Laid Flat, Joints to be Filled with  
Mortar Brushed in Dry & Well Watered  
Lime Mortar Bed (25 mm)  
Hard core Well Consolidated (150 mm)  
Compacted Ground

SECTION DETAIL OF PEDESTRIAN PAVING

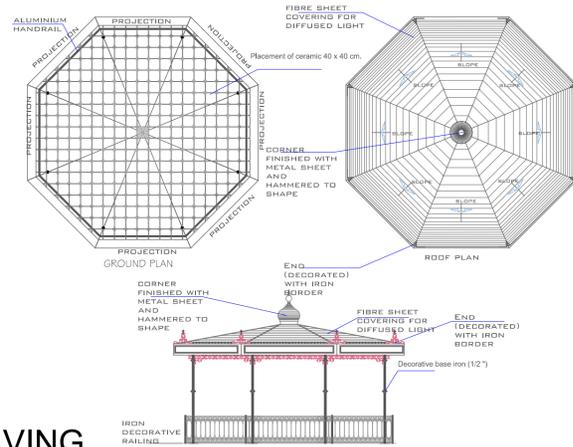


DETAIL AT GAZEBO

Grassed Yellow Sand (550 mm)  
Kota Stone Slabs (450 x 450mm)  
Cement Mortar (12 mm)  
PCC (25 mm)  
Well Consolidated Bed (75 mm)  
Plaster (12 mm)  
Brick Wall (230 mm)  
Compacted Earth

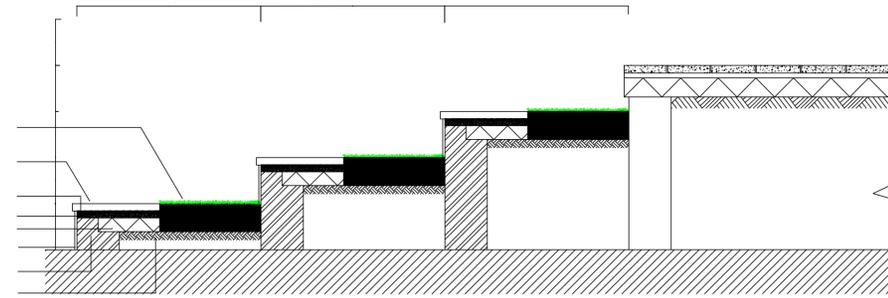


SECTION DETAIL OF OPEN AIR THEATER STEPS


GRASSED YELLOW SAND  
250 X 250 X 65 mm CONCRETE  
SETTS BUTT JOINTED JOINTS  
40 mm CEMENT MORTAR BED  
150 mm WELL CONSOLIDATED BED  
COMPACTED GROUND

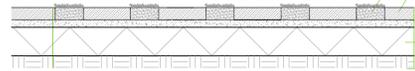


SECTION - CONCRETE SETT PAVING

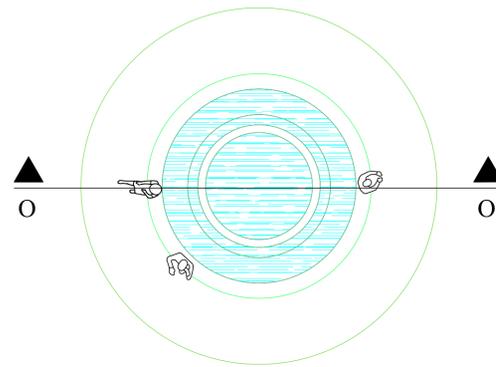

FOUNTAIN DETAIL

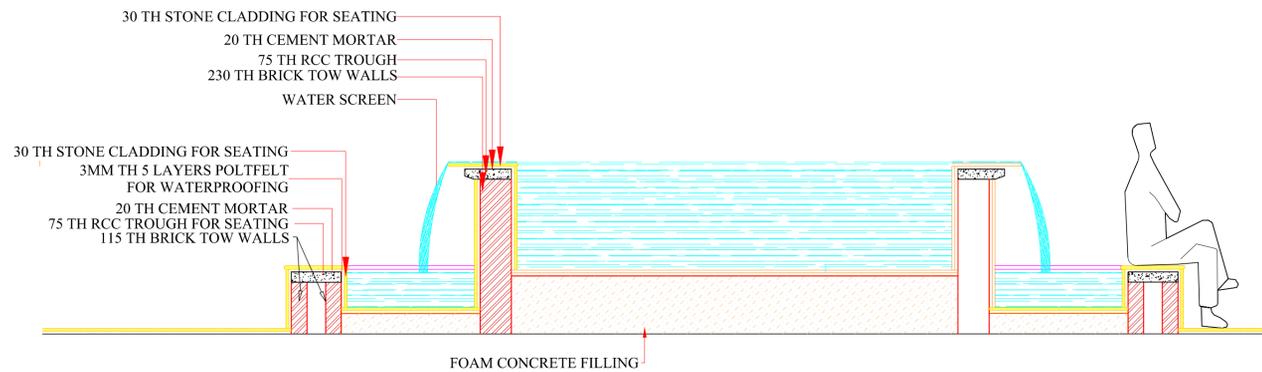

SECTION OO

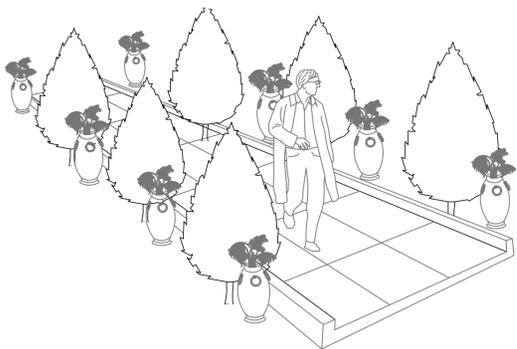

VIEW OF PEDESTRIAN MOVEMENT

# LANDSCAPE DETAIL



PROJECT TITLE

PROPOSED PLAN FOR  
'DISTRICT COURT COMPLEX  
AT DEHRADUN'



BYE LAWS :-


SETBACKS

FRONT = 15.00 M. | G. COVERAGE ALLOWED = 35%  
REAR = 6.00 M. | F.A.R. ALLOWED = 1.50  
SIDE - 1 = 6.00 M.  
SIDE - 2 = 6.00 M.

AREA STATEMENTS :-

1. TOTAL PLOT AREA	= 26314.0 SQ. M. (= 6.30 ACRES)
2. PROPOSED COVERED AREA ON BASEMENT - 1 (SERVICES)	-- 9250.00 SQ.M.
3. PROPOSED COVERED AREA ON GROUND FLOOR	-- 7462.00 SQ.M.
4. PROPOSED COVERED AREA ON FIRST FLOOR	-- 7462.00 SQ.M.
5. PROPOSED COVERED AREA ON SECOND FLOOR	-- 7462.00 SQ.M.
6. PROPOSED COVERED AREA ON THIRD FLOOR	-- 7462.00 SQ.M.
7. PROP. COVD. AREA ON 4TH FL.	-- 7462.00 SQ.M.
8. TOTAL COVERED AREA (IN F.A.R. - 12.50)	= 29848.00 SQ.M.
9. OPEN AREA ON GROUND FLOOR	-- 3063.00 SQ.M.
10. AREA OF PORCH	-- 290.62 SQ.M.
11. GROUND COVERAGE	-- 28.36 %
12. GREEN AREA	-- 17.3%
13. PROPOSED TOTAL PARKING	-- 345 ECS
14. AREA REQUIRED FOR @ 32 SQM. PER ECS.--	10880 SQM
15.	

NORTH

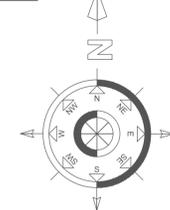

GENERAL NOTES

All Dimensions are in mm, or specified

SCALE

STUDENT DETAIL

Name - Poornima Raj Chaudhary  
Section - AR- 5-2  
Roll. No. - 1150101051

SHEET NO.

GUIDE DETAIL

PR. MOHIT AGARWAL & AR. RAMAKANT

